

DESIGN RATIONALE

FAMILY TOWNHOME HOUSING

920 Rutland Road



PROPOSAL

This application is to construct an enclave of 2-bedroom townhomes a few blocks West of the Rutland Recreation Park, and about 200m North of Rutland Middle School. This mid-block site is zoned RU1 and currently hosts a single-family home built in 1944. The site is proposed to be rezoned to MF2, consistent with the Core Area Neighborhood Land use designation.

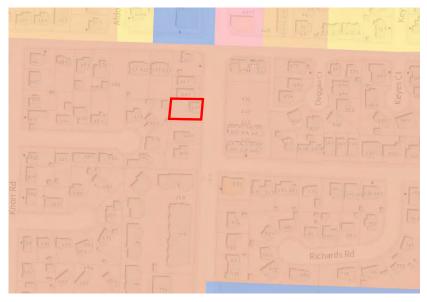


Figure 1: Site location.



ARCHITECTURE FORM & CHARACTER



These 3-storey buildings have a distinctly modern residential personality. The massing is articulated with simple and effective uses of varied cladding materials with a particular design focus on street facing elevations. A street-facing entry from Rutland Road animates the pedestrian realm, while robust landscaping consisting of trees/shrubs delineates the boundary between public and private space.

The onsite amenity space aligns along a backyard walkway that leads to a shared picnic table, which is shaded under a large existing tree in the Northwest corner of the property. This at-grade amenity space is augmented by patio spaces on both the 2nd and 3rd floors of each home for residents to enjoy.







Figure 2: Landscape Plan

SUMMARY

This development is a key housing component to be added within the context of North Rutland. It complies with the zoning bylaw in all aspects, follows the OCP guidelines for appropriate development and delivers 5 much needed ground-oriented homes on an infill lot. We kindly seek support from staff and Council in this endeavor.



RUTLAND 5-PLEX

ISSUED FOR DP, 2023-07-25



ARCHITECTURAL

NEW TOWN ARCHITECTURE & ENGINEERING 200-1464 ST. PAUL STREET KELOWNA, BC V1Y 2E6

e: roman@newtownservices.net t: (250) 860-8185

A1.01D ZONING & BYLAW

A2.01D SITE PLAN A3.01D LEVEL 1 FLOOR PLAN

A3.02D LEVEL 2 FLOOR PLAN A3.03D LEVEL 3 FLOOR PLAN

A3.04D ROOF PLAN A3.11D TYPICAL 1A FLOOR PLAN A3.12D TYPICAL 2A FLOOR PLAN

A4.00D MATERIALS A4.01D BUILDING ELEVATIONS

A4.02D BUILDING ELEVATIONS A9.01D RENDERINGS

LANDSCAPE

ECORA #200, 2045 ENTERPRISE WAY KELÓWNA, BC V1Y 9T5

e: achim.muller@ecora.ca t: (250) 300-8750

CONCEPTUAL LANDSCAPE PLAN WATER CONSERVATION/IRRIGATION PLAN

ALL CONTRACTORS ARE REQUIRED TO PERFORM THEIR WORK AND SUPPLY THEIR PRODUCTS IN COMPLIANCE WITH ALL BUILDING CODES AND LAWS OF THE PROVINCE OF BRITISH COLUMBIA This drawing is an instrument of service and the property of New Town Services. The use of this drawing shall be restricted to the original site for which it was prepared and publication thereof is expressly limited to such use. This drawing must not be scaled Verify all dimensions and datums prior to

> **NEW TOWN** URBAN PLANNING CIVIL ENGINEERING www.newtownservices.ca

1 2023-07-25 ISSUED FOR DP

920 RUTLAND ROAD

project address 920 RUTLAND ROAD KELOWNA, BC V1X 3B7 project no.

file no. F:\1 Projects\4194 Rutland Rd 920\4194-4 Dwgs\4194-4.1 Current\Rvt\4194-920 Rutlar drawing title **COVER PAGE**

PROJECT NAME

ADDRESS: 920 RUTLAND ROAD, KELOWNA, V1X 3B7, BRITISH COLUMBIA, CANADA

LOT 7; PLAN No. KAP44228; ROLL 6224352

<u>GRADES:</u> EXISTING: SMALL DECLINE TO SW CORNER PROPOSED: FLAT

NUMBER OF BUILDINGS: 1 BUILDINGS (5 UNITS)

3x 2-BED TOWNHOUSE 2x 3-BED TOWNHOUSE

ZONING ANALYSIS

SOUTH RU1 LARGE LOT HOUSING (BUILT IN 2013) EAST N/A N/A	RU1 - URBAN RESIDE	NTIAL	MF2 - MULTI-FAMILY TOWNHOUSE HOUSING
ZONE USE	FUTURE LAND USE (2040 OCP)	C-NHD (CORE AREA NEIGHBOURHOOD)
ADJACENT LAND USES: NORTH RU4 SOUTH RU1 EAST N/A N/A LOW DENSITY CLUSTER HOUSING (BUILT IN 2010) LARGE LOT HOUSING (BUILT IN 2013) N/A	TRANSIT SUPPORTE	D CORRIDOR	Υ
		70NF	ПОЕ
	NORTH SOUTH	ES: RU4 RU1	LOW DENSITY CLUSTER HOUSING (BUILT IN 2016 LARGE LOT HOUSING (BUILT IN 2013)

MF2 ZONING REQUIREMENTS


	REQUIRED:	PROPOSED:
SITE AREA (m²)	900.0m²	770.69m² (ORIGINAL BEFORE DEDICATION 848.40
SITE WIDTH (m)	20.0m	24.26m
SITE DEPTH (m)	30.0m	34.83m
MAXIMUM SITE COVERAG	GE OF BUILDINGS (%) 55.0%	30.9%
MAXIMUM SITE COVERAG	GE OF BUILDING, PARKING, IMPERMEABLE SU 80.0%	JRFACES (%) 67.2%


DEVELOPMENT REQUIREMENTS

	REQUIRED:	PROPOSED:
TOTAL NUMBER & TYPES	S OF UNITS:	
TOTAL NUMBER & TIPE	OF UNITS.	5 UNITS
FLOOR AREA (GFA/NFA)(I		
	770.69m² MAXIMUM (BASED ON 1.0 FAR)	525.29m ² (237.99m ² GFA FOR SITE COVERAGE)
FLOOR AREA RATIO:		
BASE	1.0	0.68
STREETSCAPE BONUS	N/A	N/A
RENT/AFFORD BONUS	N/A	N/A
DIUI DING UEIGUE ().		
BUILDING HEIGHT (m): OCP DESIGNATED	11.0m (3 STOREYS)	0.9m (2.STODEVS)
MAX. ST-SCAPE BONUS	N/A	9.8m (3 STOREYS) N/A
WAX. 31-3CAPE BUNUS	N/A	IN/A
MAX. CONTINUOUS FROM	ITAGE:	
	100.0m	10.8m
SETBACKS (m):	0.0	0.0
FRONT (EAST) SIDE A (NORTH)	2.0m 3.0m	3.0m 10.5m
SIDE A (NOKTH) SIDE B (SOUTH)	3.0m	3.0m
BACK (WEST)	4.5m	4.5m
5/10/1 (11201)	1.5	1.0111
REAR SETBACK TO ACCE	SSORY BUILDINGS	
	N/A	N/A
AMENITY SPACE (m²):		
AMENITI OI AGE (III).		
COMMON AMENITY	20.00m² (min. 4m²/UNIT)	AREA PROVIDED WITHIN SETBACKS
TOTAL	20.00m²	23.8m²
COMMON AND DDIVATE A	MENITY SDACE	
COMMON AND PRIVATE A LEVEL 1	INIENTY SPACE	295.0m²
LEVEL 1 LEVEL 2		16.36m²
LEVEL 3		12.05m²
SUB-TOTAL		
		323.41m²
		323.41m²
		323.41m²
2-BED (QTY)	3 x 25.0m ² = 75.0m ²	323.41m²
2-BED (QTY) 3-BED (QTY)	2x 25.0m² = 50.0m²	
2-BED (QTY) 3-BED (QTY)		323.41m ² 323.41m ²
2-BED (QTY) 3-BED (QTY)	2x 25.0m² = 50.0m²	
2-BED (QTY) 3-BED (QTY) TOTAL	2x 25.0m ² = 50.0m ² 125.0m ²	
2-BED (QTY) 3-BED (QTY) TOTAL PARKING STALLS (TRANS	2x 25.0m ² = 50.0m ² 125.0m ² SIT SUPPORTIVE CORRIDOR):	323.41m²
2-BED (QTY) 3-BED (QTY) TOTAL PARKING STALLS (TRANS 2-BED	2x 25.0m ² = 50.0m ² 125.0m ² SIT SUPPORTIVE CORRIDOR): 3 x 1.1 = 3.3	323.41m²
2-BED (QTY) 3-BED (QTY) TOTAL PARKING STALLS (TRANS 2-BED 3-BED	2x 25.0m ² = 50.0m ² 125.0m ² SIT SUPPORTIVE CORRIDOR): 3 x 1.1 = 3.3 2 x 1.4 = 2.8	323.41m ² 3 4
2-BED (QTY) 3-BED (QTY) TOTAL PARKING STALLS (TRANS 2-BED 3-BED VISITOR (HC)	2x 25.0m ² = 50.0m ² 125.0m ² SIT SUPPORTIVE CORRIDOR): 3 x 1.1 = 3.3 2 x 1.4 = 2.8 5 x 0.14 = 0.7	323.41m ² 3 4 1
2-BED (QTY) 3-BED (QTY) TOTAL PARKING STALLS (TRANS 2-BED 3-BED VISITOR (HC)	2x 25.0m ² = 50.0m ² 125.0m ² SIT SUPPORTIVE CORRIDOR): 3 x 1.1 = 3.3 2 x 1.4 = 2.8	323.41m ² 3 4
2-BED (QTY) 3-BED (QTY) TOTAL PARKING STALLS (TRANS 2-BED 3-BED VISITOR (HC) TOTAL	2x 25.0m ² = 50.0m ² 125.0m ² SIT SUPPORTIVE CORRIDOR): 3 x 1.1 = 3.3 2 x 1.4 = 2.8 5 x 0.14 = 0.7	323.41m ² 3 4 1
2-BED (QTY) 3-BED (QTY) TOTAL PARKING STALLS (TRANS 2-BED 3-BED VISITOR (HC) TOTAL RENTAL REDUCTION SHARE REDUCTION	2x 25.0m ² = 50.0m ² 125.0m ² SIT SUPPORTIVE CORRIDOR): 3 x 1.1 = 3.3 2 x 1.4 = 2.8 5 x 0.14 = 0.7 6.8 N/A N/A	323.41m ² 3 4 1 8
2-BED (QTY) 3-BED (QTY) TOTAL PARKING STALLS (TRANS 2-BED 3-BED VISITOR (HC) TOTAL RENTAL REDUCTION SHARE REDUCTION BIKE BONUS REDUCTION	2x 25.0m ² = 50.0m ² 125.0m ² SIT SUPPORTIVE CORRIDOR): 3 x 1.1 = 3.3 2 x 1.4 = 2.8 5 x 0.14 = 0.7 6.8 N/A N/A N/A	3 4 1 8 N/A N/A N/A
2-BED (QTY) 3-BED (QTY) TOTAL PARKING STALLS (TRANS 2-BED 3-BED VISITOR (HC) TOTAL RENTAL REDUCTION SHARE REDUCTION BIKE BONUS REDUCTION	2x 25.0m ² = 50.0m ² 125.0m ² SIT SUPPORTIVE CORRIDOR): 3 x 1.1 = 3.3 2 x 1.4 = 2.8 5 x 0.14 = 0.7 6.8 N/A N/A N/A	323.41m ² 3 4 1 8 N/A N/A
2-BED (QTY) 3-BED (QTY) TOTAL PARKING STALLS (TRANS 2-BED 3-BED VISITOR (HC) TOTAL RENTAL REDUCTION SHARE REDUCTION BIKE BONUS REDUCTION TOTAL (INC. REDUCTIONS	2x 25.0m ² = 50.0m ² 125.0m ² SIT SUPPORTIVE CORRIDOR): 3 x 1.1 = 3.3 2 x 1.4 = 2.8 5 x 0.14 = 0.7 6.8 N/A N/A N/A N/A N/A S) N/A	3 4 1 8 N/A N/A N/A N/A N/A
2-BED (QTY) 3-BED (QTY) TOTAL PARKING STALLS (TRANS 2-BED 3-BED VISITOR (HC) TOTAL RENTAL REDUCTION SHARE REDUCTION BIKE BONUS REDUCTION TOTAL (INC. REDUCTIONS	2x 25.0m ² = 50.0m ² 125.0m ² SIT SUPPORTIVE CORRIDOR): 3 x 1.1 = 3.3 2 x 1.4 = 2.8 5 x 0.14 = 0.7 6.8 N/A N/A N/A	3 4 1 8 N/A N/A N/A
PER UNIT BREAKDOWN: 2-BED (QTY) 3-BED (QTY) TOTAL PARKING STALLS (TRANS 2-BED 3-BED VISITOR (HC) TOTAL RENTAL REDUCTION SHARE REDUCTION BIKE BONUS REDUCTION TOTAL (INC. REDUCTIONS) DRIVE ISLE (WIDTH) REGULAR STALL RATIO	2x 25.0m ² = 50.0m ² 125.0m ² SIT SUPPORTIVE CORRIDOR): 3 x 1.1 = 3.3 2 x 1.4 = 2.8 5 x 0.14 = 0.7 6.8 N/A N/A N/A N/A N/A S) N/A	3 4 1 8 N/A N/A N/A N/A N/A
2-BED (QTY) 3-BED (QTY) TOTAL PARKING STALLS (TRANS 2-BED 3-BED VISITOR (HC) TOTAL RENTAL REDUCTION SHARE REDUCTION BIKE BONUS REDUCTION TOTAL (INC. REDUCTIONS) DRIVE ISLE (WIDTH)	2x 25.0m ² = 50.0m ² 125.0m ² SIT SUPPORTIVE CORRIDOR): 3 x 1.1 = 3.3 2 x 1.4 = 2.8 5 x 0.14 = 0.7 6.8 N/A N/A N/A N/A N/A N/A N/A S) N/A 6.5m	3 4 4 1 8 N/A N/A N/A N/A 6.5m


BIKE STALLS (PER DWELLING UNIT):
LONG TERM 0
SHORT TERM 4
TOTAL 4

END OF TRIP FACILITY Y/N WASH & REPAIR STATION Y/N

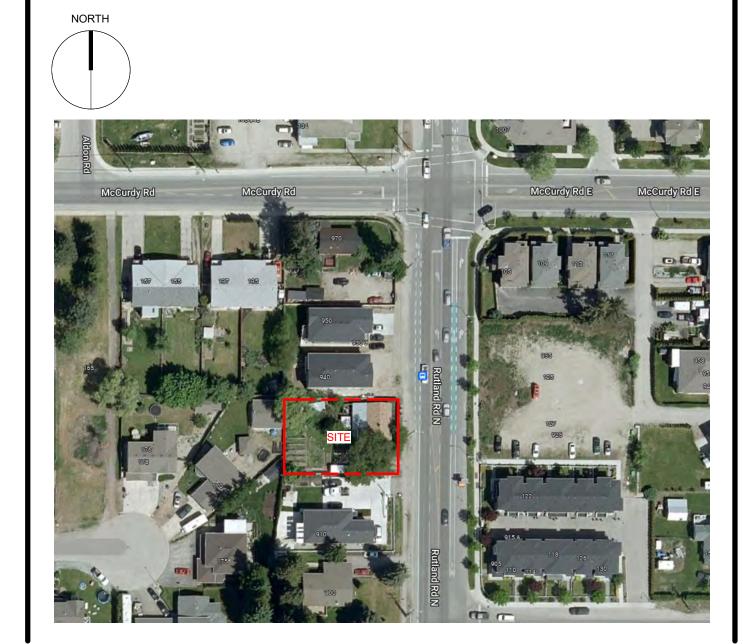

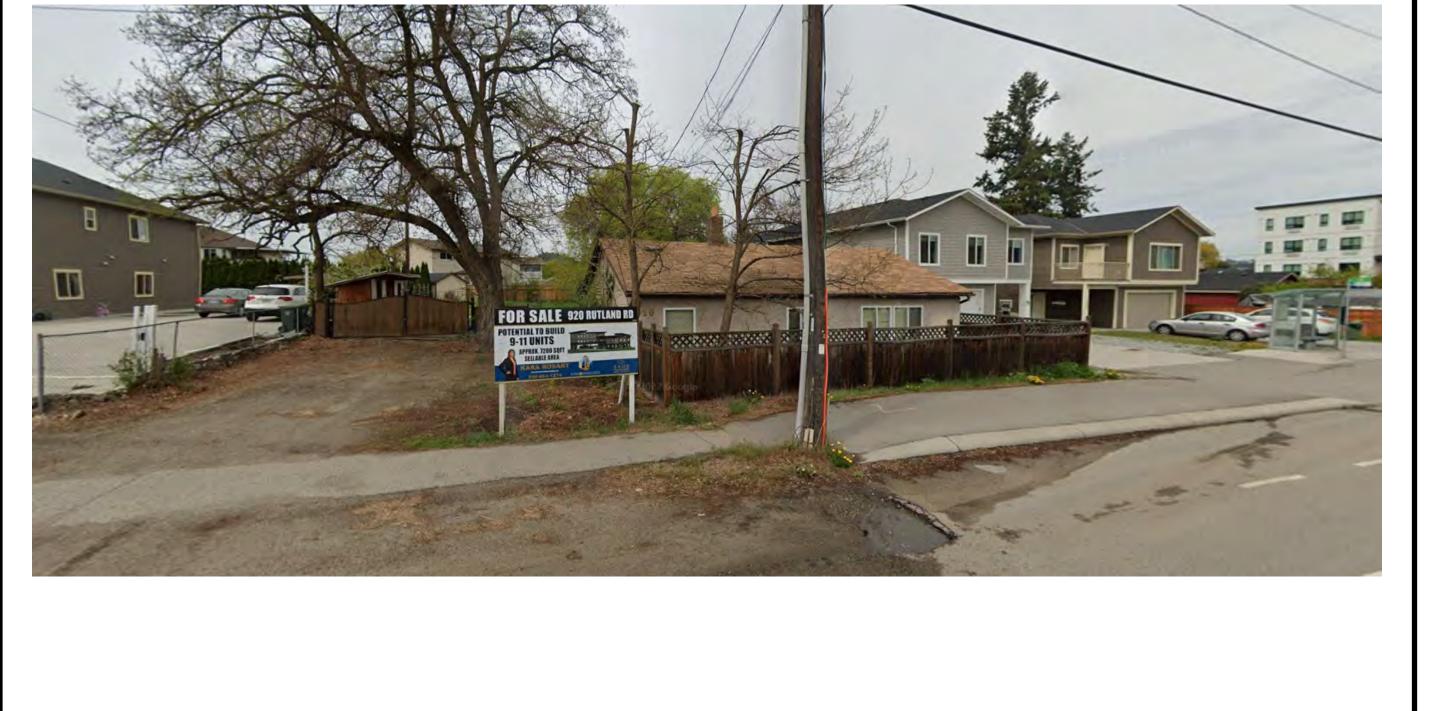



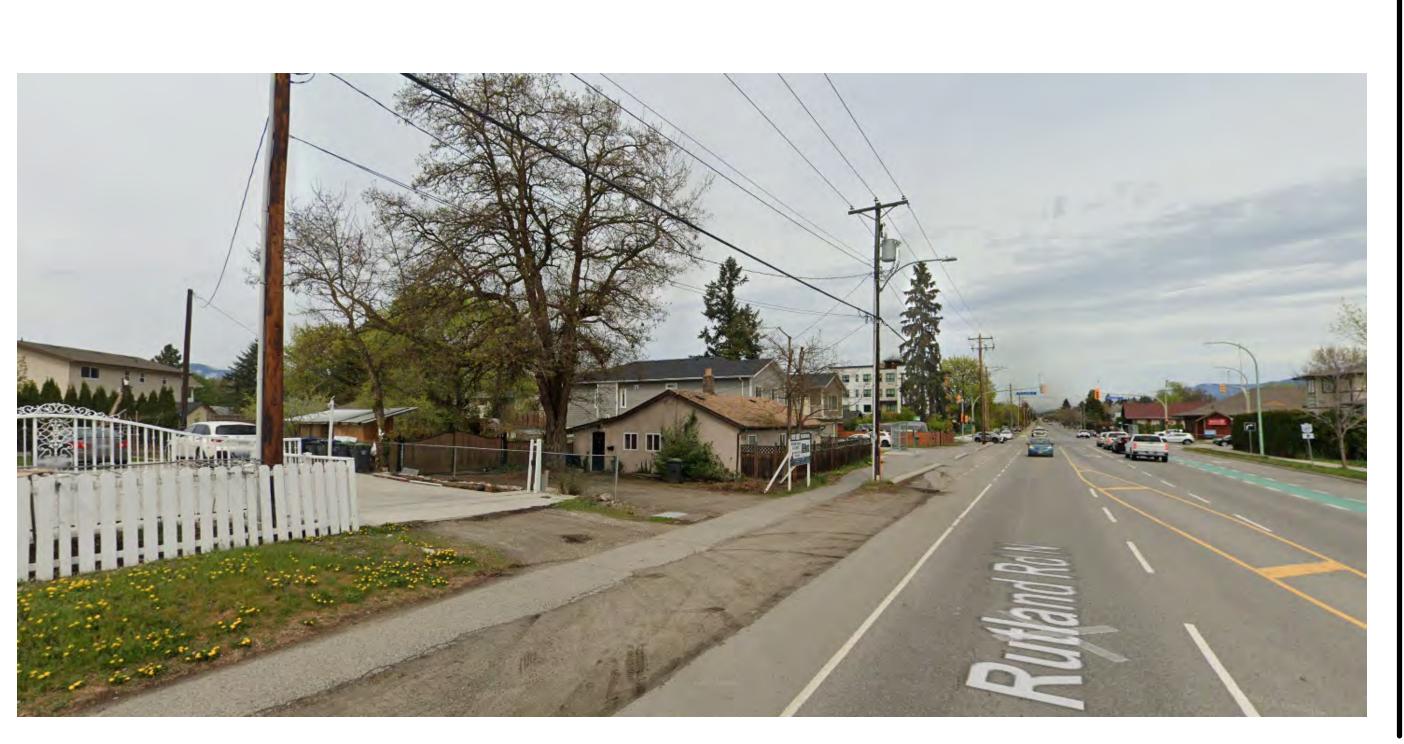

This drawing is an instrument of service and the property of New Town Services. The use of this drawing shall be restricted to the original site for which it was prepared and publication thereof is expressly limited to such use. This drawing must not be scaled Verify all dimensions and datums prior to commencement of work. Report all errors and omissions to the Architect.



ALL CONTRACTORS ARE REQUIRED TO PERFORM THEIR WORK AND SUPPLY THEIR PRODUCTS IN COMPLIANCE WITH ALL BUILDING CODES AND LAWS OF THE PROVINCE OF BRITISH COLUMBIA

NEW TOWN ARCHITECT URE URBAN PLANNING CIVIL ENGINEERING

www.newtownservices.ca



BRITISH COLUMNIA				
vis	sions			
	DATE	DESCRIPTION		
	2023-07-25	ISSUED FOR DP		


No.	DATE	DESCRIPTION
1	2023-07-25	ISSUED FOR DP

920 RUTLAND ROAD


project address 920 RUTLAND ROAD KELOWNA, BC V1X 3B7

file no. F:\1 Projects\4194 Rutland Rd 920\4194-4 Dwgs\4194-4.1 Current\Rvt\4194-920 Rutlan drawing title **ZONING &**

BYLAW

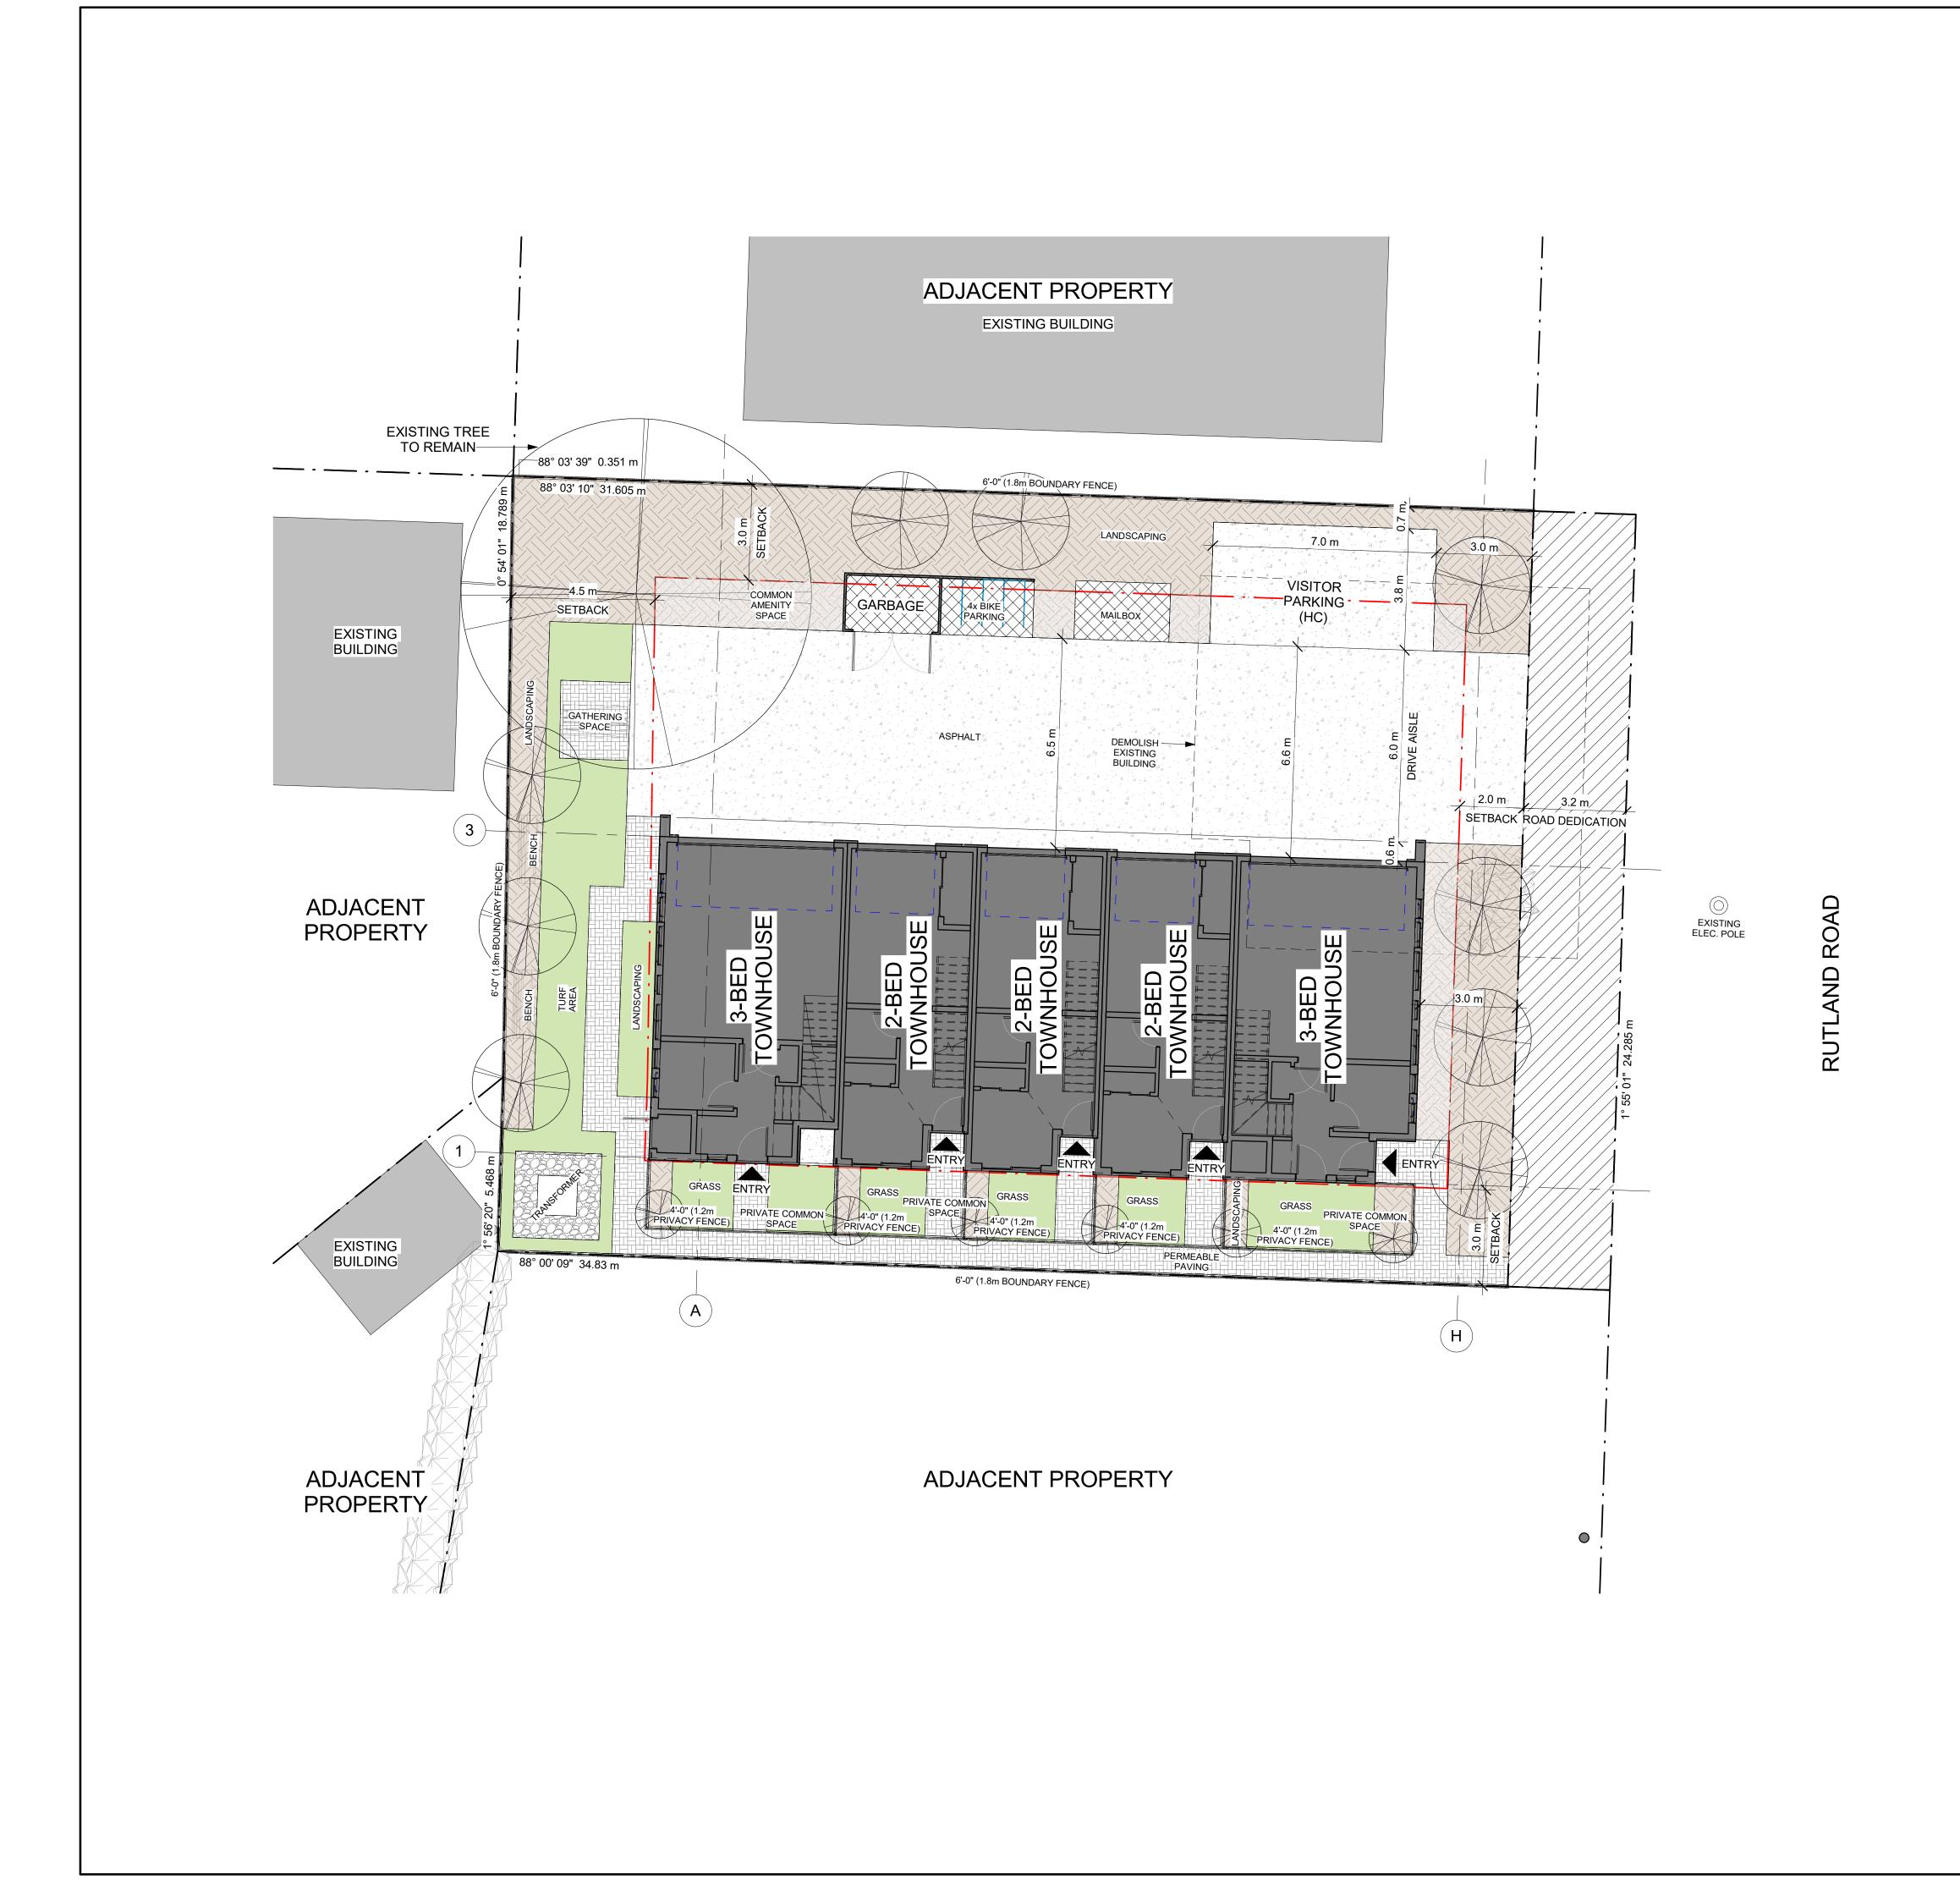

KEYNOTES - SITE I.D DESCRIPTION

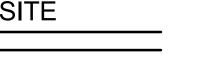



limited to such use.

This drawing must not be scaled

commencement of work.

Verify all dimensions and datums prior to



ALL CONTRACTORS ARE REQUIRED TO PERFORM THEIR WORK AND SUPPLY THEIR PRODUCTS IN COMPLIANCE WITH ALL BUILDING CODES AND LAWS OF THE PROVINCE OF BRITISH COLUMBIA

This drawing is an instrument of service and the property of New Town Services. The use of this drawing shall be restricted to the original site for which it was prepared and publication thereof is expressly




ANTISH COLLINIA IN THE PROPERTY OF THE PROPERT		
	.,	1411475
Revi	sions	
No.	DATE	DESCRIPTION
1	2023-07-25	ISSUED FOR DP

920 RUTLAND ROAD


project address 920 RUTLAND ROAD KELOWNA, BC V1X 3B7 4194 project no.

file no. F:\1 Projects\4194 Rutland Rd 920\4194-4 Dwgs\4194-4.1 Current\Rvt\4194-920 Rutlan drawing title SITE PLAN

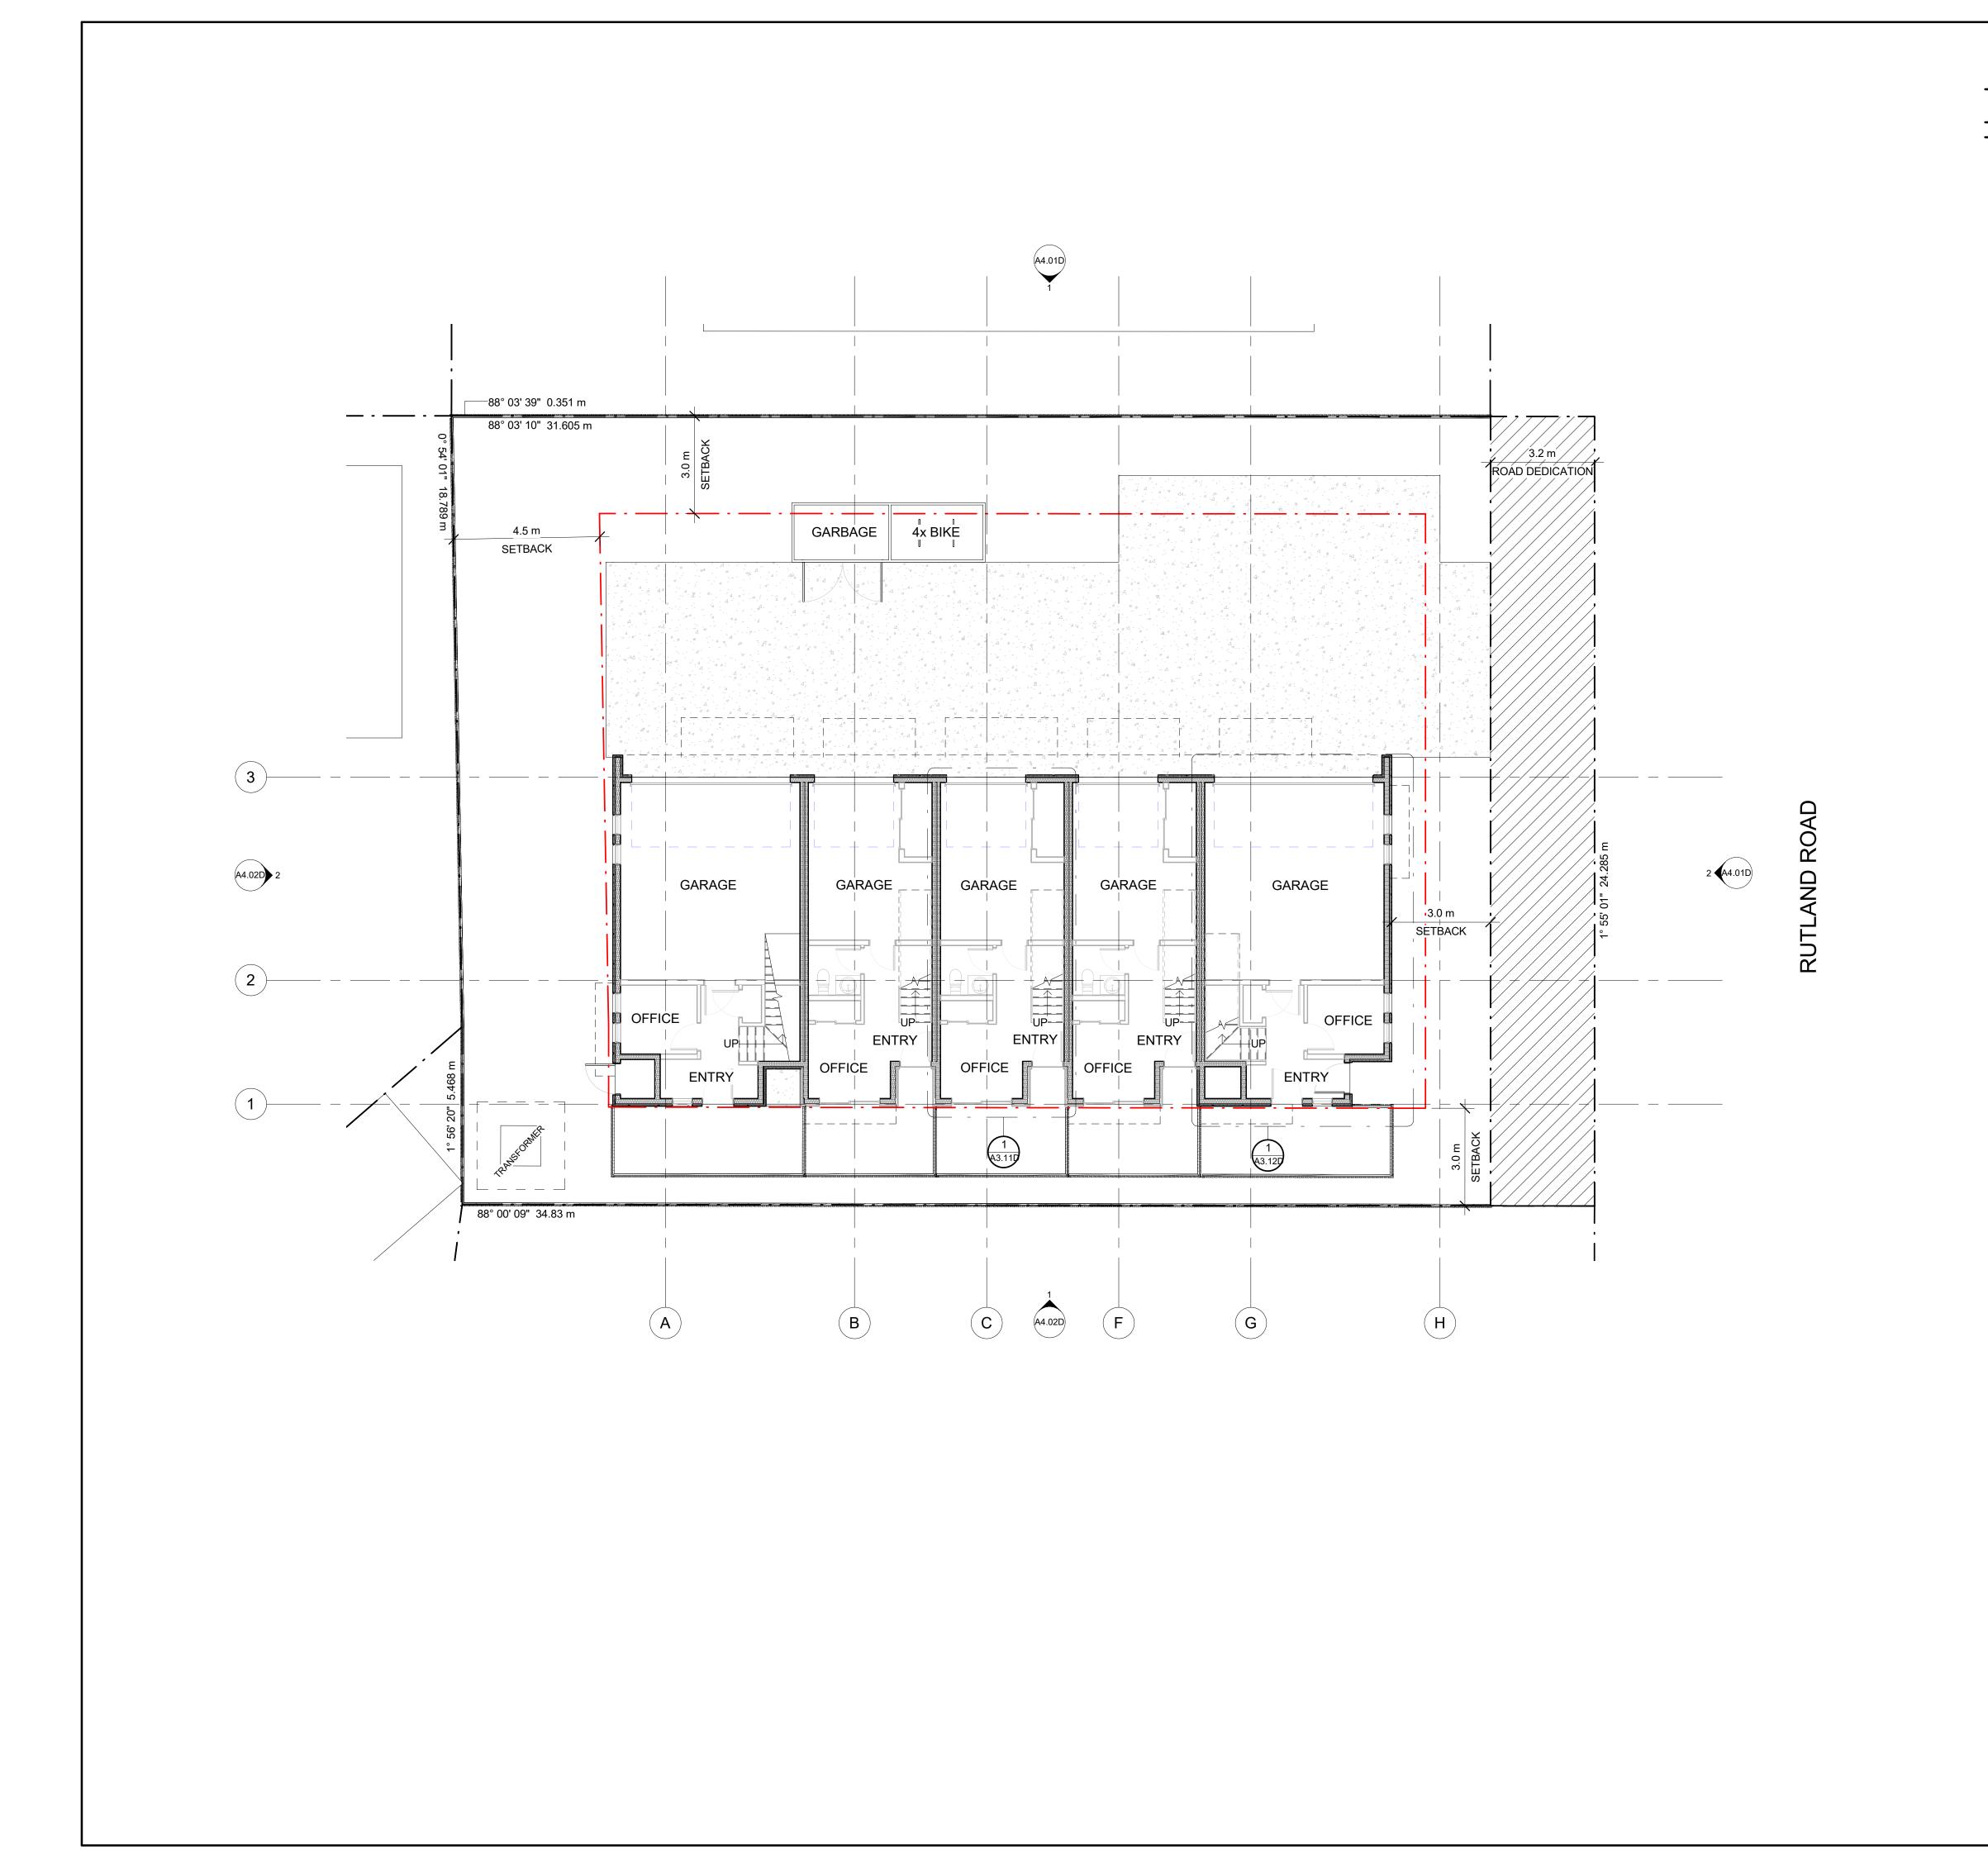

KEYNOTES - FLOOR PLAN I.D DESCRIPTION



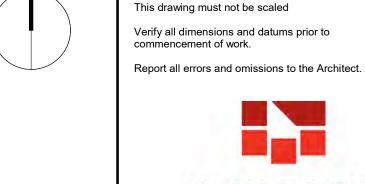

limited to such use.



ALL CONTRACTORS ARE REQUIRED TO PERFORM THEIR WORK AND SUPPLY THEIR PRODUCTS IN COMPLIANCE WITH ALL BUILDING CODES AND LAWS OF THE PROVINCE OF BRITISH COLUMBIA

This drawing is an instrument of service and the property of New Town Services. The use of this drawing shall be restricted to the original site for which it was prepared and publication thereof is expressly




TINITISH CO THE				
Revi	isions			
No.	DATE	DESCRIPTION		
1	2023-07-25	ISSUED FOR DP		

920 RUTLAND ROAD

project address 920 RUTLAND ROAD KELOWNA, BC V1X 3B7

project no. file no. F:\1 Projects\4194 Rutland Rd 920\4194-4 Dwgs\4194-4.1 Current\Rvt\4194-920 Rutland B.rvt LEVEL 1 FLOOR PLAN

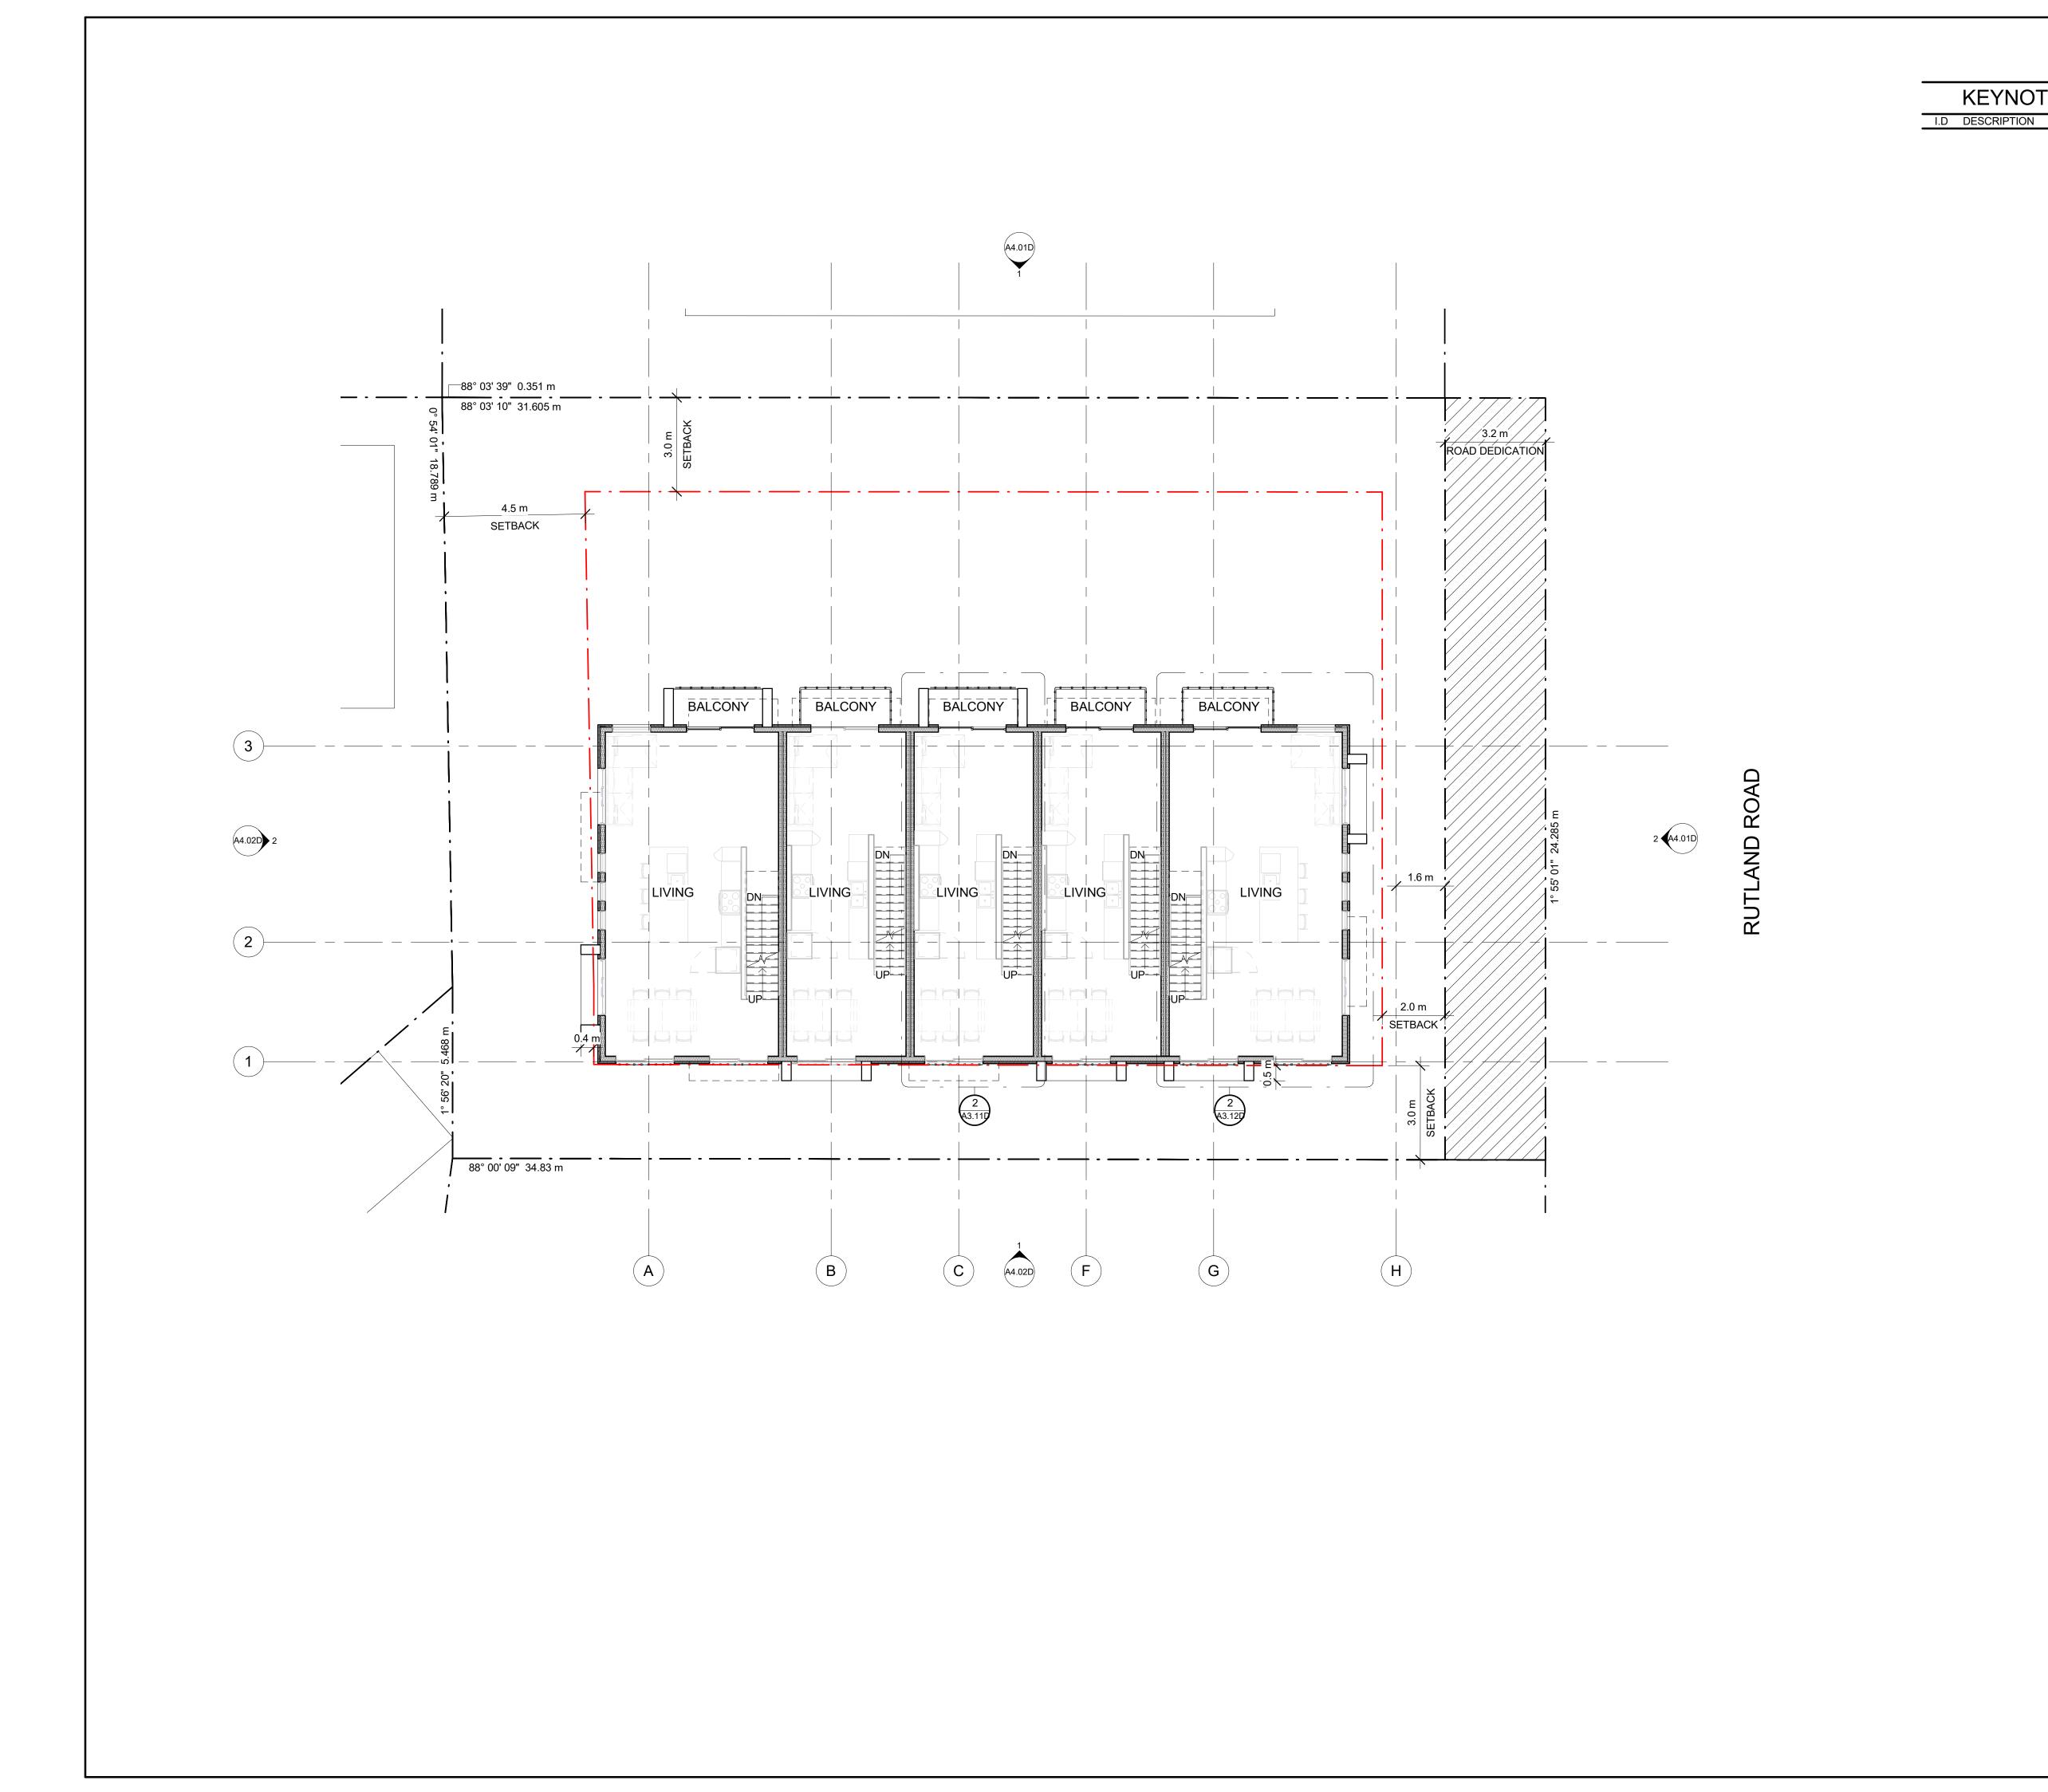





920 RUTLAND ROAD

ALL CONTRACTORS ARE REQUIRED TO PERFORM THEIR WORK AND SUPPLY THEIR PRODUCTS IN COMPLIANCE WITH ALL BUILDING CODES AND LAWS OF THE PROVINCE OF BRITISH COLUMBIA

This drawing is an instrument of service and the property of New Town Services. The use of this drawing shall be restricted to the original site for which it was prepared and publication thereof is expressly

limited to such use.

This drawing must not be scaled

commencement of work.

No. DATE

Verify all dimensions and datums prior to

Report all errors and omissions to the Architect.

NEW TOWN ARCHITECTURE URBAN PLANNING CIVIL ENGINEERING www.newtownservices.ca


DESCRIPTION

1 2023-07-25 ISSUED FOR DP


project address 920 RUTLAND ROAD KELOWNA, BC V1X 3B7


project no. file no. F:\1 Projects\4194 Rutland Rd 920\4194-4 Dwgs\4194-4.1 Current\Rvt\4194-920 Rutland B.rvt LEVEL 2 FLOOR

PLAN

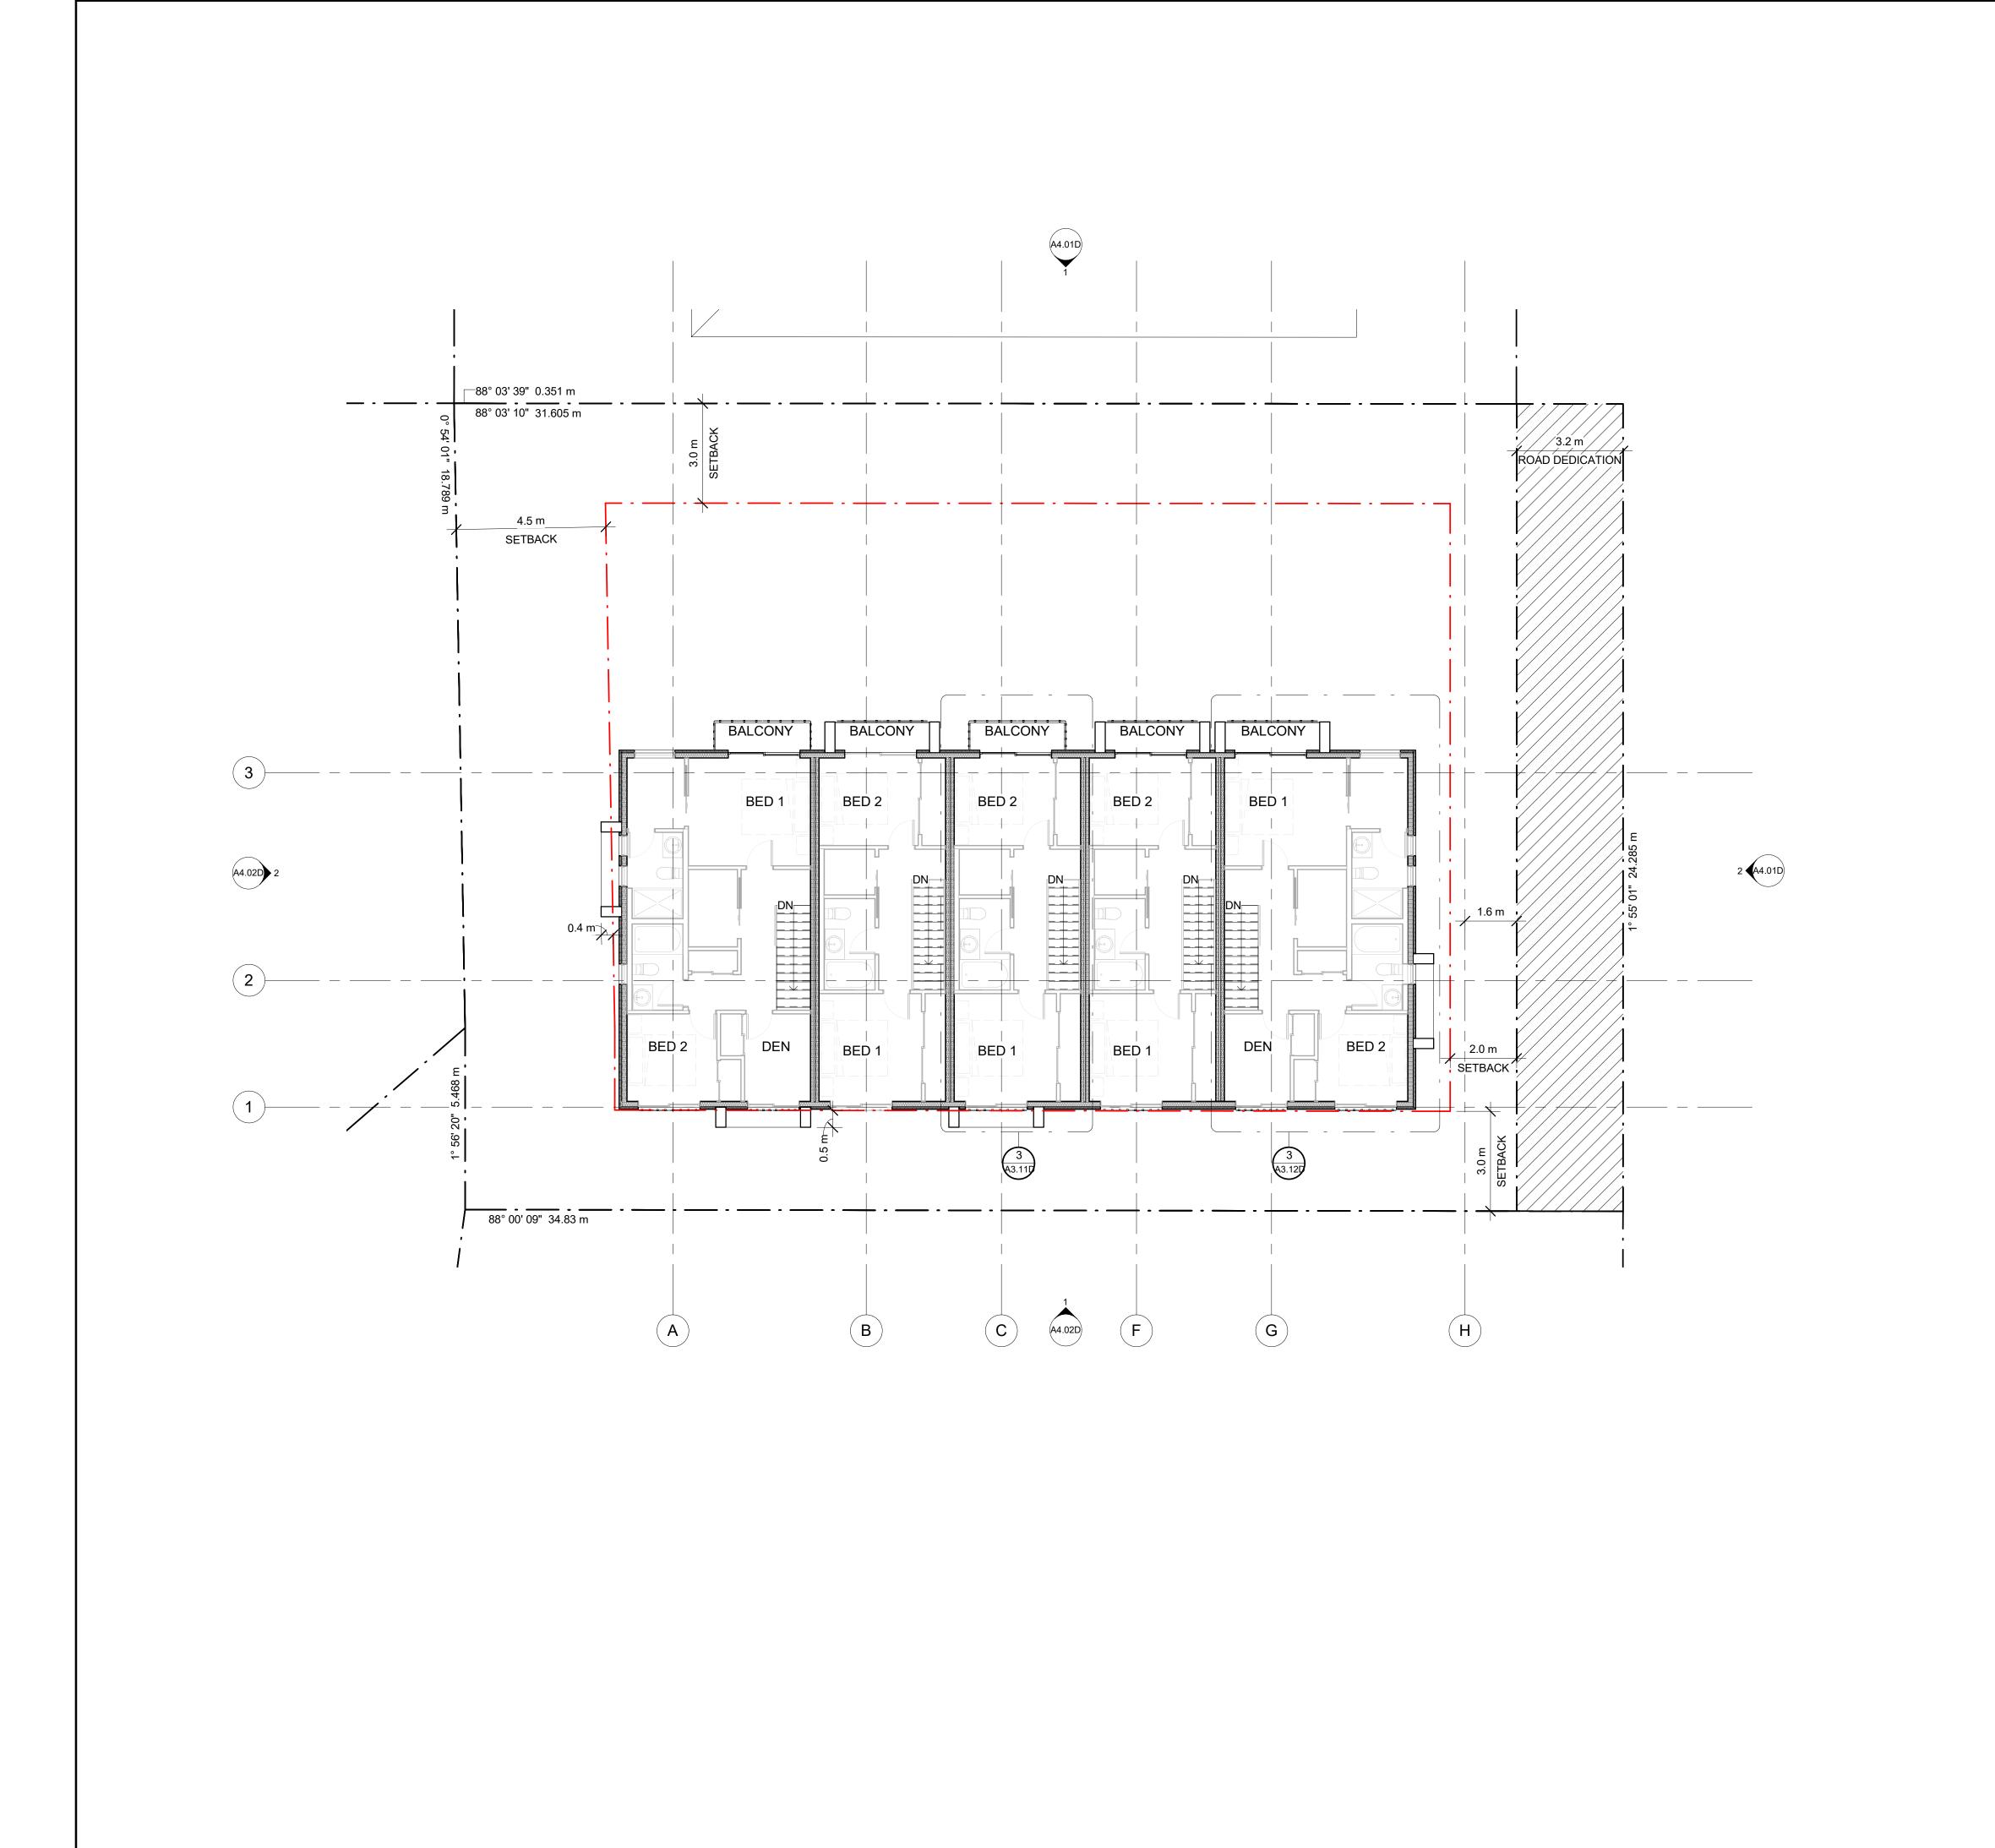

KEYNOTES - FLOOR PLAN I.D DESCRIPTION

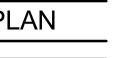

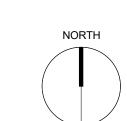

ALL CONTRACTORS ARE REQUIRED TO PERFORM THEIR WORK AND SUPPLY THEIR PRODUCTS IN COMPLIANCE WITH ALL BUILDING CODES AND LAWS OF THE PROVINCE OF BRITISH COLUMBIA

This drawing is an instrument of service and the property of New Town Services. The use of this drawing shall be restricted to the original site for which it was prepared and publication thereof is expressly

limited to such use.

This drawing must not be scaled

commencement of work.

No. DATE

Verify all dimensions and datums prior to

Report all errors and omissions to the Architect.

NEW TOWN ARCHITECTURE URBAN PLANNING CIVIL ENGINEERING www.newtownservices.ca

DESCRIPTION


1 2023-07-25 ISSUED FOR DP

920 RUTLAND ROAD

project address 920 RUTLAND ROAD KELOWNA, BC V1X 3B7 project no.

file no. F:\1 Projects\4194 Rutland Rd 920\4194-4 Dwgs\4194-4.1 Current\Rvt\4194-920 Rutland B.rvt LEVEL 3 FLOOR

PLAN

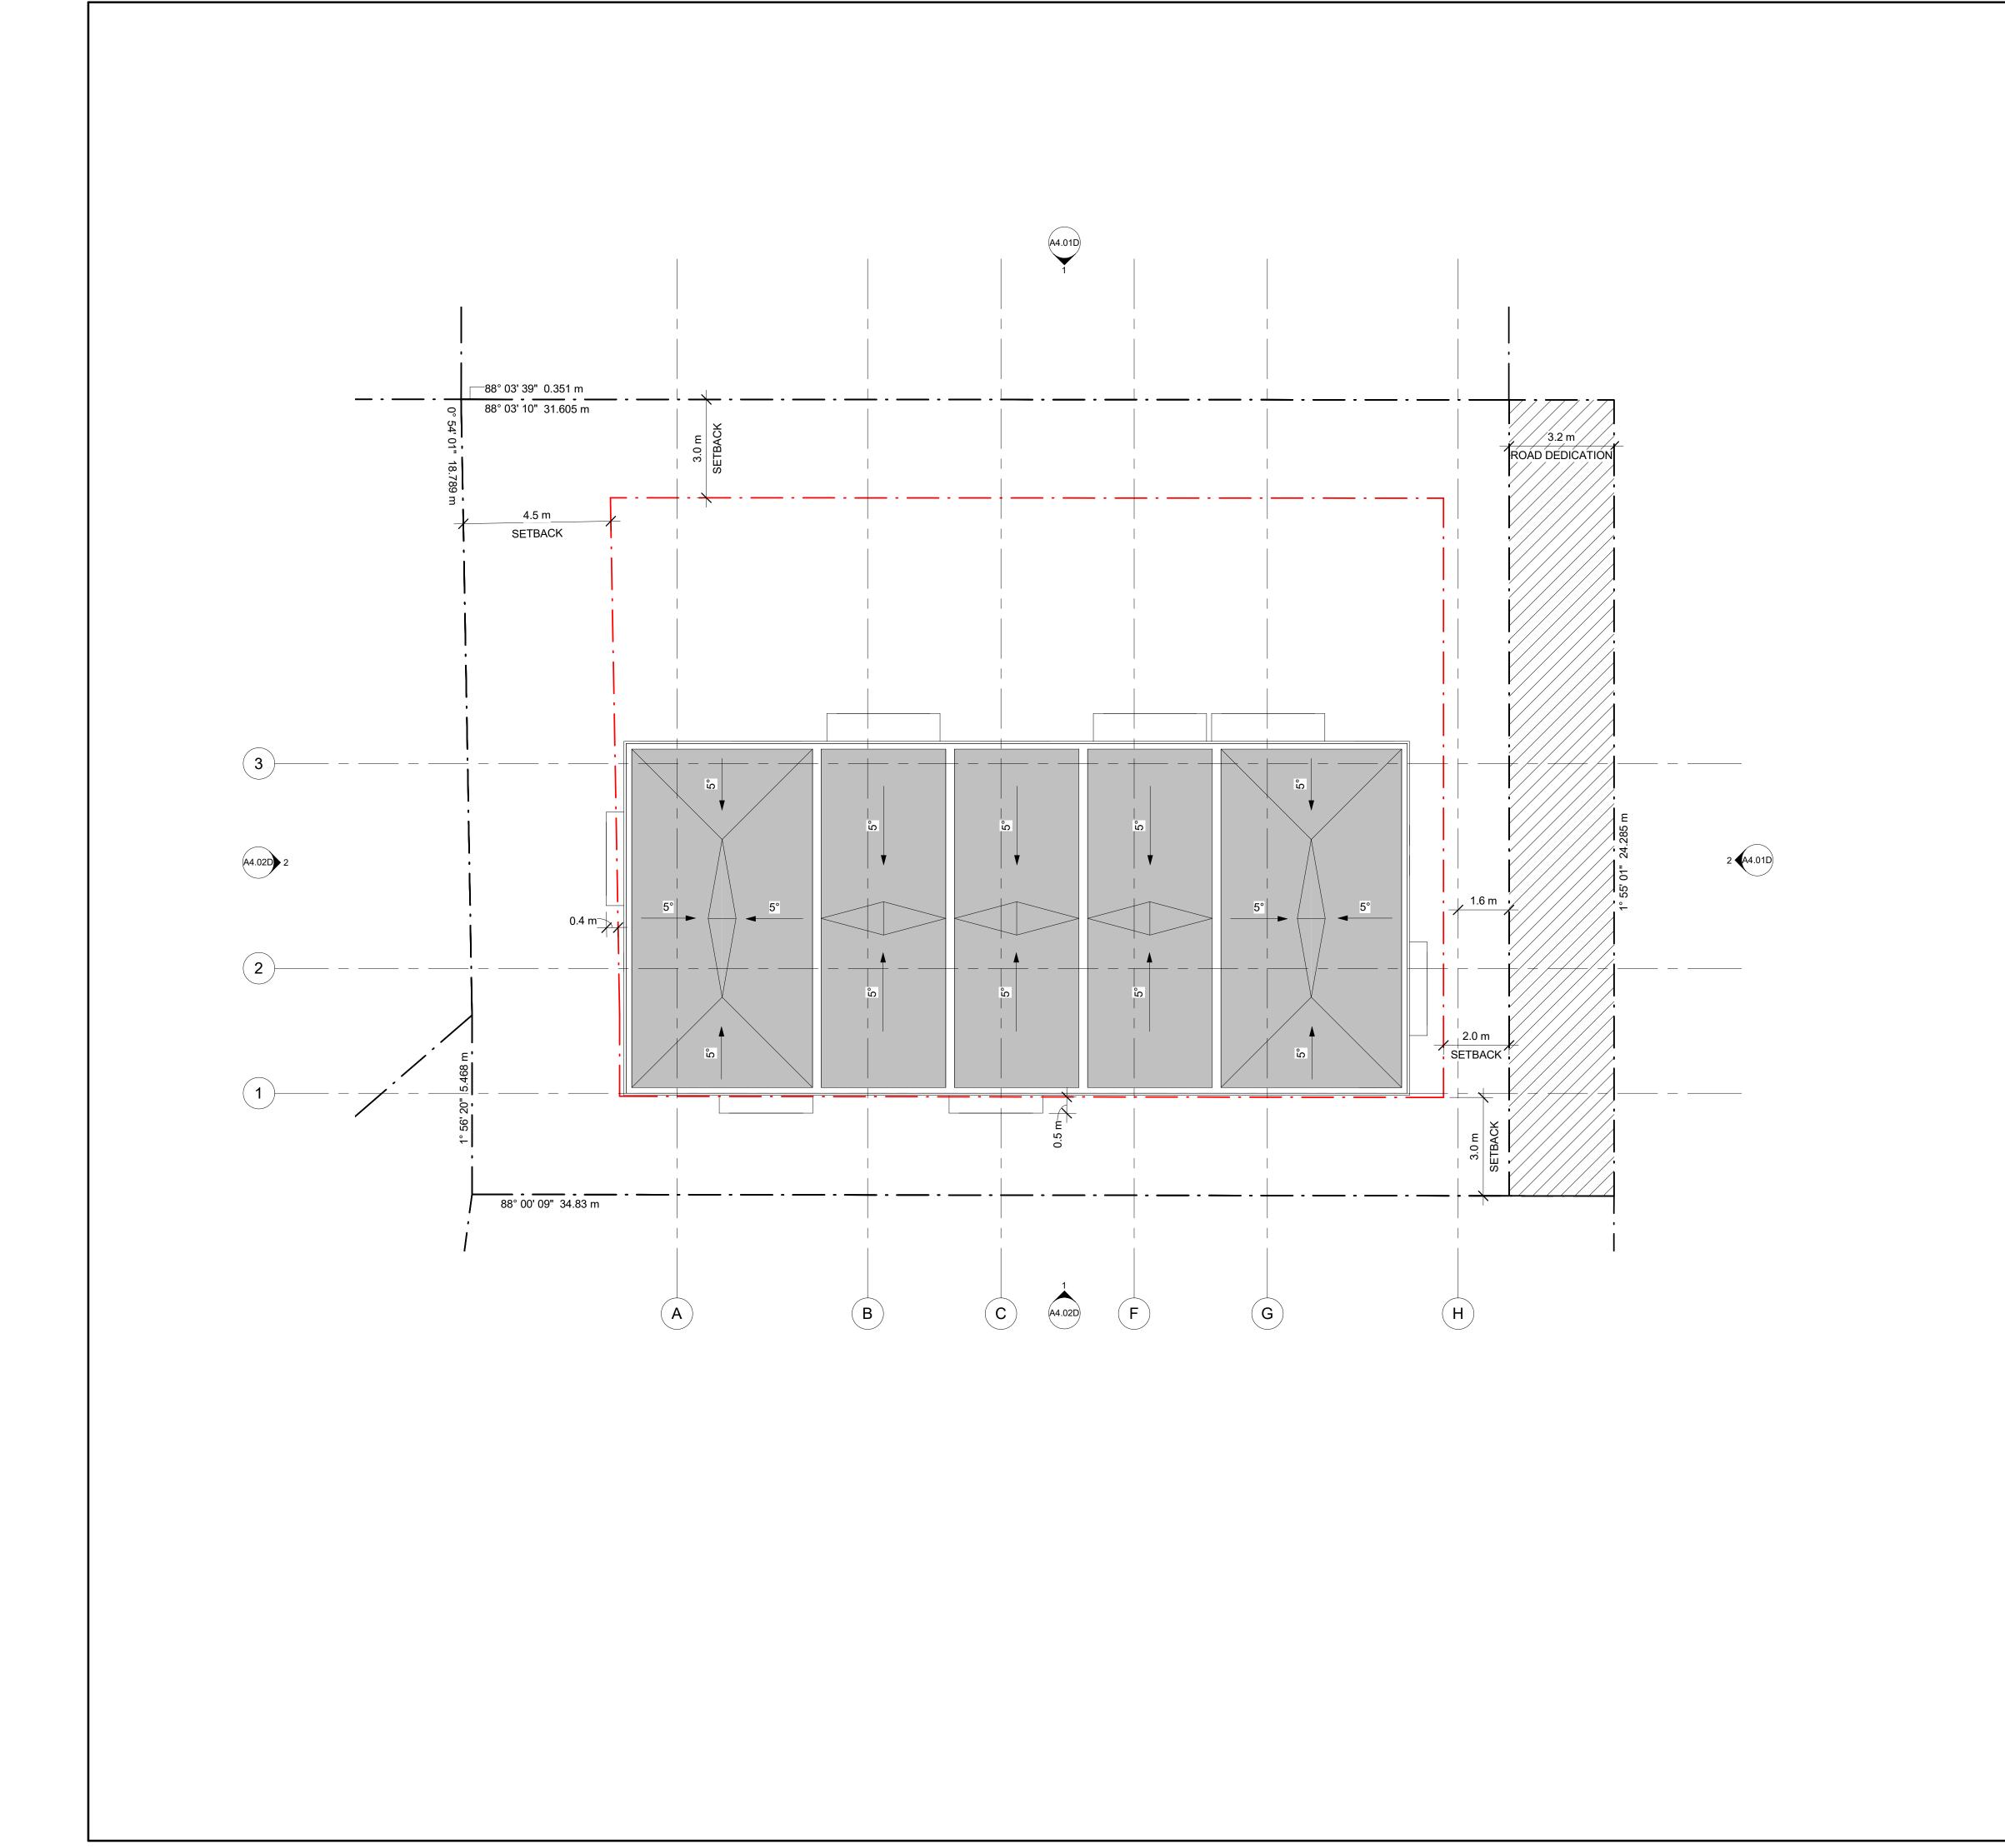

project title 920 RUTLAND ROAD project address

920 RUTLAND ROAD KELOWNA, BC V1X 3B7 4194

ALL CONTRACTORS ARE REQUIRED TO PERFORM THEIR WORK AND SUPPLY THEIR PRODUCTS IN COMPLIANCE WITH ALL BUILDING CODES AND LAWS OF THE PROVINCE OF BRITISH COLUMBIA

This drawing is an instrument of service and the property of New Town Services. The use of this drawing shall be restricted to the original site for which it was prepared and publication thereof is expressly

limited to such use.

This drawing must not be scaled

commencement of work.

No. DATE

Verify all dimensions and datums prior to

Report all errors and omissions to the Architect.

NEW TOWN

ARCHITECT URE URBAN PLANNING CIVIL ENGINEERING www.newtownservices.ca

DESCRIPTION

1 2023-07-25 ISSUED FOR DP

project no. file no. F:\1 Projects\4194 Rutland Rd 920\4194-4 Dwgs\4194-4.1 Current\Rvt\4194-920 Rutland B.rv

drawing title **ROOF PLAN**

10' - 1" 3' - 3" 3072 LIVING SERVICE GARAGE 其)= = ()() KITCHEN STAIRS 3' - 6 1/2", 3' - 9 1/4", 1077 DINING 0' - 10 3/4" 271 9' - 3 1/4" 4' - 0 3/4" 8' - 7 1/2" 3' - 9 3/4" 2824 1<u>3' - 4"</u> 2629 13' - 4" 1163 1240 4064

2 UNIT 1A - LEVEL 2
A3.02D 1/4" = 1'-0"

1 UNIT 1A - LEVEL 1
A3.01D 1/4" = 1'-0"

11' - 4"

KEYNOTES - FLOOR PLAN

13' - 4"

4064 9' - 4"

2843 10' - 7"

BED 2

3' - 3 1/2" 3' - 9 1/4"

135 BED 1

10' - 10 1/4"

3310

3 UNIT 1A - LEVEL 3
A3.03D 1/4" = 1'-0"

131

STAIRS

LAUNDRY














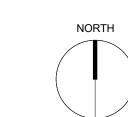



ALL CONTRACTORS ARE REQUIRED TO PERFORM THEIR WORK AND SUPPLY THEIR PRODUCTS IN COMPLIANCE WITH ALL BUILDING CODES AND LAWS OF THE PROVINCE OF BRITISH COLUMBIA

This drawing is an instrument of service and the property of New Town Services. The use of this drawing shall be restricted to the original site for which it was prepared and publication thereof is expressly

limited to such use.

This drawing must not be scaled

Verify all dimensions and datums prior to





No.	DATE	DESCRIPTION
1	2023-07-25	ISSUED FOR DP
•	2020 0. 20	I COSESTORES

project title 920 RUTLAND ROAD

project address 920 RUTLAND ROAD KELOWNA, BC V1X 3B7 project no. 4194

file no. F:\1 Projects\4194 Rutland Rd 920\4194-4 Dwgs\4194-4.1 Current\Rvf\4194-920 Rutland B.rv drawing title TYPICAL 1A

FLOOR PLAN

KEYNOTES - FLOOR PLAN

I.D DESCRIPTION

8' - 3" 2516

236 WIC

ENS.

5' - 1 1/4" 1' - 0 1/4"

9' - 5 1/2"

2883

10' - 10"

3 UNIT 2A - LEVEL 3
A3.03D 1/4" = 1'-0"

2392 3301 BED 1 222 LIVING 1303 STAIRS LAUNDR\[™] 1637 STAIRS = KITCHEN #==== #==== |<u>|</u>||===== 224 DINING 233 DEN 232 BED 2 2' - 4 1/2" 724 19' - 1" 7' - 3" 2210 9' - 9 3/4" 9' - 3 1/4" 2992 5817

9' - 3 3/4"

2 UNIT 2A - LEVEL 2
A3.02D 1/4" = 1'-0"

GARAGE

10' - 6"

3202

19' - 1"

5817

8' - 3 3/4" -

2535

213 OFFICE

4' - 0"

1219

MECH

4' - 7"

1 UNIT 2A - LEVEL 1
A3.01D 1/4" = 1'-0"

7' - 10 1/4"

ALL CONTRACTORS ARE REQUIRED TO PERFORM THEIR WORK AND SUPPLY THEIR PRODUCTS IN COMPLIANCE WITH ALL BUILDING CODES AND LAWS OF THE PROVINCE OF BRITISH COLUMBIA

This drawing is an instrument of service and the property of New Town Services. The use of this drawing shall be restricted to the original site for which it was prepared and publication thereof is expressly limited to such use.

This drawing must not be scaled Verify all dimensions and datums prior to

commencement of work.

Report all errors and omissions to the Architect.

NEW TOWN ARCHITECTURE URBAN PLANNING CIVIL ENGINEERING www.newtownservices.ca

No. DATE DESCRIPTION 1 2023-07-25 ISSUED FOR DP

project title 920 RUTLAND ROAD

project address 920 RUTLAND ROAD KELOWNA, BC V1X 3B7

project no. 4194 file no. F:\1 Projects\4194 Rutland Rd 920\4194-4 Dwgs\4194-4.1 Current\Rvf\4194-920 Rutland B.rv drawing title

TYPICAL 2A FLOOR PLAN



NEWTECHWOOD

THIN PROFILE WOOD BATTON

MANUFACTURER:
PRODUCT: SLIDING DOOR
COLOUR & CODE:

MANUFACTURER:

PRODUCT:



MANUFACTURER:
PRODUCT: BROOMED CONCRETE
COLOUR & CODE:



SAMPLE FOR COLOUR
PURPOSES ONLY



NEWTECHWOOD

CEDAR

WIDE PROFILE WOOD BATTON

MANUFACTURER:

COLOUR & CODE:

PRODUCT:

MANUFACTURER:
PRODUCT: FRAMELESS GLASS BALUSTRADE
COLOUR & CODE:



MANUFACTURER:
PRODUCT: PREMIABLE
COLOUR & CODE: SAND
I.D NUMBER:



PREMIABLE PAVERS
SAND

MANUFACTURER:
PRODUCT:
COLOUR & CODE:
I.D NUMBER:



MANUFACTURER: T.B.C
PRODUCT: COMPOSITE PANEL
COLOUR & CODE: WHITE
I.D NUMBER:

SAMPLE FOR COLOUR
PURPOSES ONLY

MANUFACTURER: PRODUCT: COLOUR & CODE: I.D NUMBER:

WINDOW/BALCONY FRAMES



NEWTECHWOOD GARBAGE/BIKE ENCOLSURE CEDAR UH61



MANUFACTURER: PRODUCT: COLOUR & CODE:

MANUFACTURER:

COLOUR & CODE:

PRODUCT:

I.D NUMBER:

T.B.C

BLACK

COMPOSITE PANEL

SAMPLE FOR COLOUR

PURPOSES ONLY



URBAN RACKS

MOGUL

ALL CONTRACTORS ARE REQUIRED TO PERFORM THEIR WORK AND SUPPLY THEIR PRODUCTS IN COMPLIANCE WITH ALL BUILDING CODES AND LAWS OF THE PROVINCE OF BRITISH COLUMBIA

This drawing is an instrument of service and the

This drawing is an instrument of service and the property of New Town Services. The use of this drawing shall be restricted to the original site for which it was prepared and publication thereof is expressly limited to such use.

This drawing must not be scaled

Verify all dimensions and datums prior to commencement of work.



NEW TOWN
ARCHITECTURE
URBAN PLANNING

CIVIL ENGINEERING www.newtownservices.ca



Revisions

No. DATE DESCRIPTION

1 2023-07-25 ISSUED FOR DP

DRO LINUT ONL

project title
920 RUTLAND ROAD

project address

920 RUTLAND ROAD
KELOWNA, BC V1X 3B7

file no. F:\1 Projects\4194 Rutland Rd 920\41944 Dwgs\41944.1 Current\Rvi\4194920 Rutla

designed Designer scale 1:10

drawn Author checked

A4.00D



(c)

LEVEL 1 407.5 m

NORTH ELEVATION
A3.01D 1/8" = 1'-0"

2 EAST ELEVATION A3.01D 1/8" = 1'-0"

3.0 m SETBACK 3.0 m SETBACK 4. 4. 9. 1. ROOF 1369' - 3" LEVEL 3 1358' - 6 1/4" LEVEL 2 1347' - 9 1/2" LEVEL 1 407.5 m 2 3 5. 10.

KEYNOTES - ELEVATION

I.D DESCRIPTION

MATERIAL LEGEND

- 1. THIN PROFILE WOOD BATTON, NEWTECHWOOD, UH61 CEDAR
- WIDE PROFILE WOOD BATTON, NEWTECHWOOD, UH58 CEDAR
- COMPOSITE PANEL (SMOOTH) ALUCOBOND, ALUCOBOND PLUS (CLASSIC WHITE)
- COMPOSITE PANEL (SMOOTH) ALUCOBOND, ALUCOBOND PLUS (CLASSIC BLACK)
- 5. FRAMELESS GLASS BALUSTRADE
- 6. EXTERIOR GLAZED DOOR w/ PREFINISHED BLACK FRAME
- EXTERIOR SOLID DOOR w/ PREFINISHED BLACK FRAME
- PREFINISHED GARAGE DOOR
- EXTERIOR WINDOW w/ PREFINISHED BLACK FRAME
- GARBAGE AND BIKE PARKING ENCLOSURE
- 11. 1.8m (6'-0") PROPERTY FENCE
- 12. 1.2m (4'-0") PRIVACY FENCE

ALL CONTRACTORS ARE REQUIRED TO PERFORM THEIR WORK AND SUPPLY THEIR PRODUCTS IN COMPLIANCE WITH ALL BUILDING CODES AND LAWS OF THE PROVINCE OF BRITISH COLUMBIA

This drawing is an instrument of service and the property of New Town Services. The use of this drawing shall be restricted to the original site for which it was prepared and publication thereof is expressly limited to such use.

This drawing must not be scaled

Verify all dimensions and datums prior to commencement of work.

Report all errors and omissions to the Architect.



NEW TOWN ARCHITECTURE URBAN PLANNING CIVIL ENGINEERING

www.newtownservices.ca



No. DATE DESCRIPTION 1 2023-07-25 ISSUED FOR DP

920 RUTLAND ROAD

project address 920 RUTLAND ROAD KELOWNA, BC V1X 3B7

file no. F:\1 Projects\4194 Rutland Rd 920\4194-4 Dwgs\4194-4.1 Current\Rvt\4194-920 Rutlan drawing title BUILDING **ELEVATIONS**

KEYNOTES - ELEVATION

I.D DESCRIPTION

MATERIAL LEGEND

- 1. THIN PROFILE WOOD BATTON, NEWTECHWOOD, UH61 CEDAR
- WIDE PROFILE WOOD BATTON, NEWTECHWOOD, UH58 CEDAR

- 6. EXTERIOR GLAZED DOOR w/ PREFINISHED BLACK FRAME
- EXTERIOR SOLID DOOR w/ PREFINISHED BLACK FRAME
- PREFINISHED GARAGE DOOR
- GARBAGE AND BIKE PARKING ENCLOSURE
- 11. 1.8m (6'-0") PROPERTY FENCE
- 12. 1.2m (4'-0") PRIVACY FENCE

- COMPOSITE PANEL (SMOOTH) ALUCOBOND, ALUCOBOND PLUS (CLASSIC WHITE)
- COMPOSITE PANEL (SMOOTH) ALUCOBOND, ALUCOBOND PLUS (CLASSIC BLACK)
- 5. FRAMELESS GLASS BALUSTRADE

- EXTERIOR WINDOW w/ PREFINISHED BLACK FRAME

920 RUTLAND ROAD

ALL CONTRACTORS ARE REQUIRED TO PERFORM THEIR WORK AND SUPPLY THEIR PRODUCTS IN COMPLIANCE WITH ALL BUILDING CODES AND LAWS OF THE PROVINCE OF BRITISH COLUMBIA

This drawing is an instrument of service and the property of New Town Services. The use of this drawing shall be restricted to the original site for which it was prepared and publication thereof is expressly

limited to such use.

commencement of work.

No. DATE

This drawing must not be scaled

Verify all dimensions and datums prior to

Report all errors and omissions to the Architect.

NEW TOWN

ARCHITECTURE

URBAN PLANNING CIVIL ENGINEERING

www.newtownservices.ca

DESCRIPTION

1 2023-07-25 ISSUED FOR DP

project address 920 RUTLAND ROAD KELOWNA, BC V1X 3B7

project no.

file no. F:\1 Projects\4194 Rutland Rd 920\4194-4 Dwgs\4194-4.1 Current\Rvt\4194-920 Rutland drawing title BUILDING **ELEVATIONS**

ROOF 1369' - 3" LEVEL 3 1358' - 6 1/4" EXISTING LEVEL 2 1347' - 9 1/2" LEVEL 1 407.5 m	3.0 m SETBACK AND SETBACK AND SETBACK AND SETBACK AND S	5.	4. 4. 1. 9.	3.0 m SETBACK 0.5 m	EXISTING
	10.	3	9. 3. 2. 7.	1 12.	
2 WEST ELEVATION A3.01D 1/8" = 1'-0"					

(c)

SETBACK ROAD DEDICATION

H

G 6. 9.

4.5 m

SETBACK

ROOF 1369' - 3"

LEVEL 3 1358' - 6 1/4"

LEVEL 2 1347' - 9 1/2"

SOUTH ELEVATION
A3.01D 1/8" = 1'-0"

6. 5.

1. 4. 4.



RENDERING 1 - VIEW FROM NW CORNER



RENDERING NUMBER 3 - VIEW FROM SE CROSS-STREET



RENDERING 2 - VIEW FROM ELEVATED SW



RENDERING NUMBER 4 - VIEW FROM SE AERIAL

ALL CONTRACTORS ARE REQUIRED TO PERFORM THEIR WORK AND SUPPLY THEIR PRODUCTS IN COMPLIANCE WITH ALL BUILDING CODES AND LAWS OF THE PROVINCE OF BRITISH COLUMBIA

This drawing is an instrument of service and the property of New Town Services. The use of this drawing shall be restricted to the original site for which it was prepared and publication thereof is expressly limited to such use.

This drawing must not be scaled

Verify all dimensions and datums prior to commencement of work.



NEW TOWN

ARCHITECT URE
URBAN PLANNING
CIVIL ENGINEERING
www.newtownservices.ca



Revisions

Revis	sions	
No.	DATE	DESCRIPTION
1	2023-07-25	ISSUED FOR DP

ROLL ON LONG

project title
920 RUTLAND ROAD


project address


920 RUTLAND ROAD
KELOWNA, BC V1X 3B7
project no. 41

file no. F\1 Projects\4194 Rulland Rd 920\4194-4 Dwgs\4194-4.1 Current\Rv1\4194-920 Rulland Rd 920\4194-5 DERINGS

A9.01D



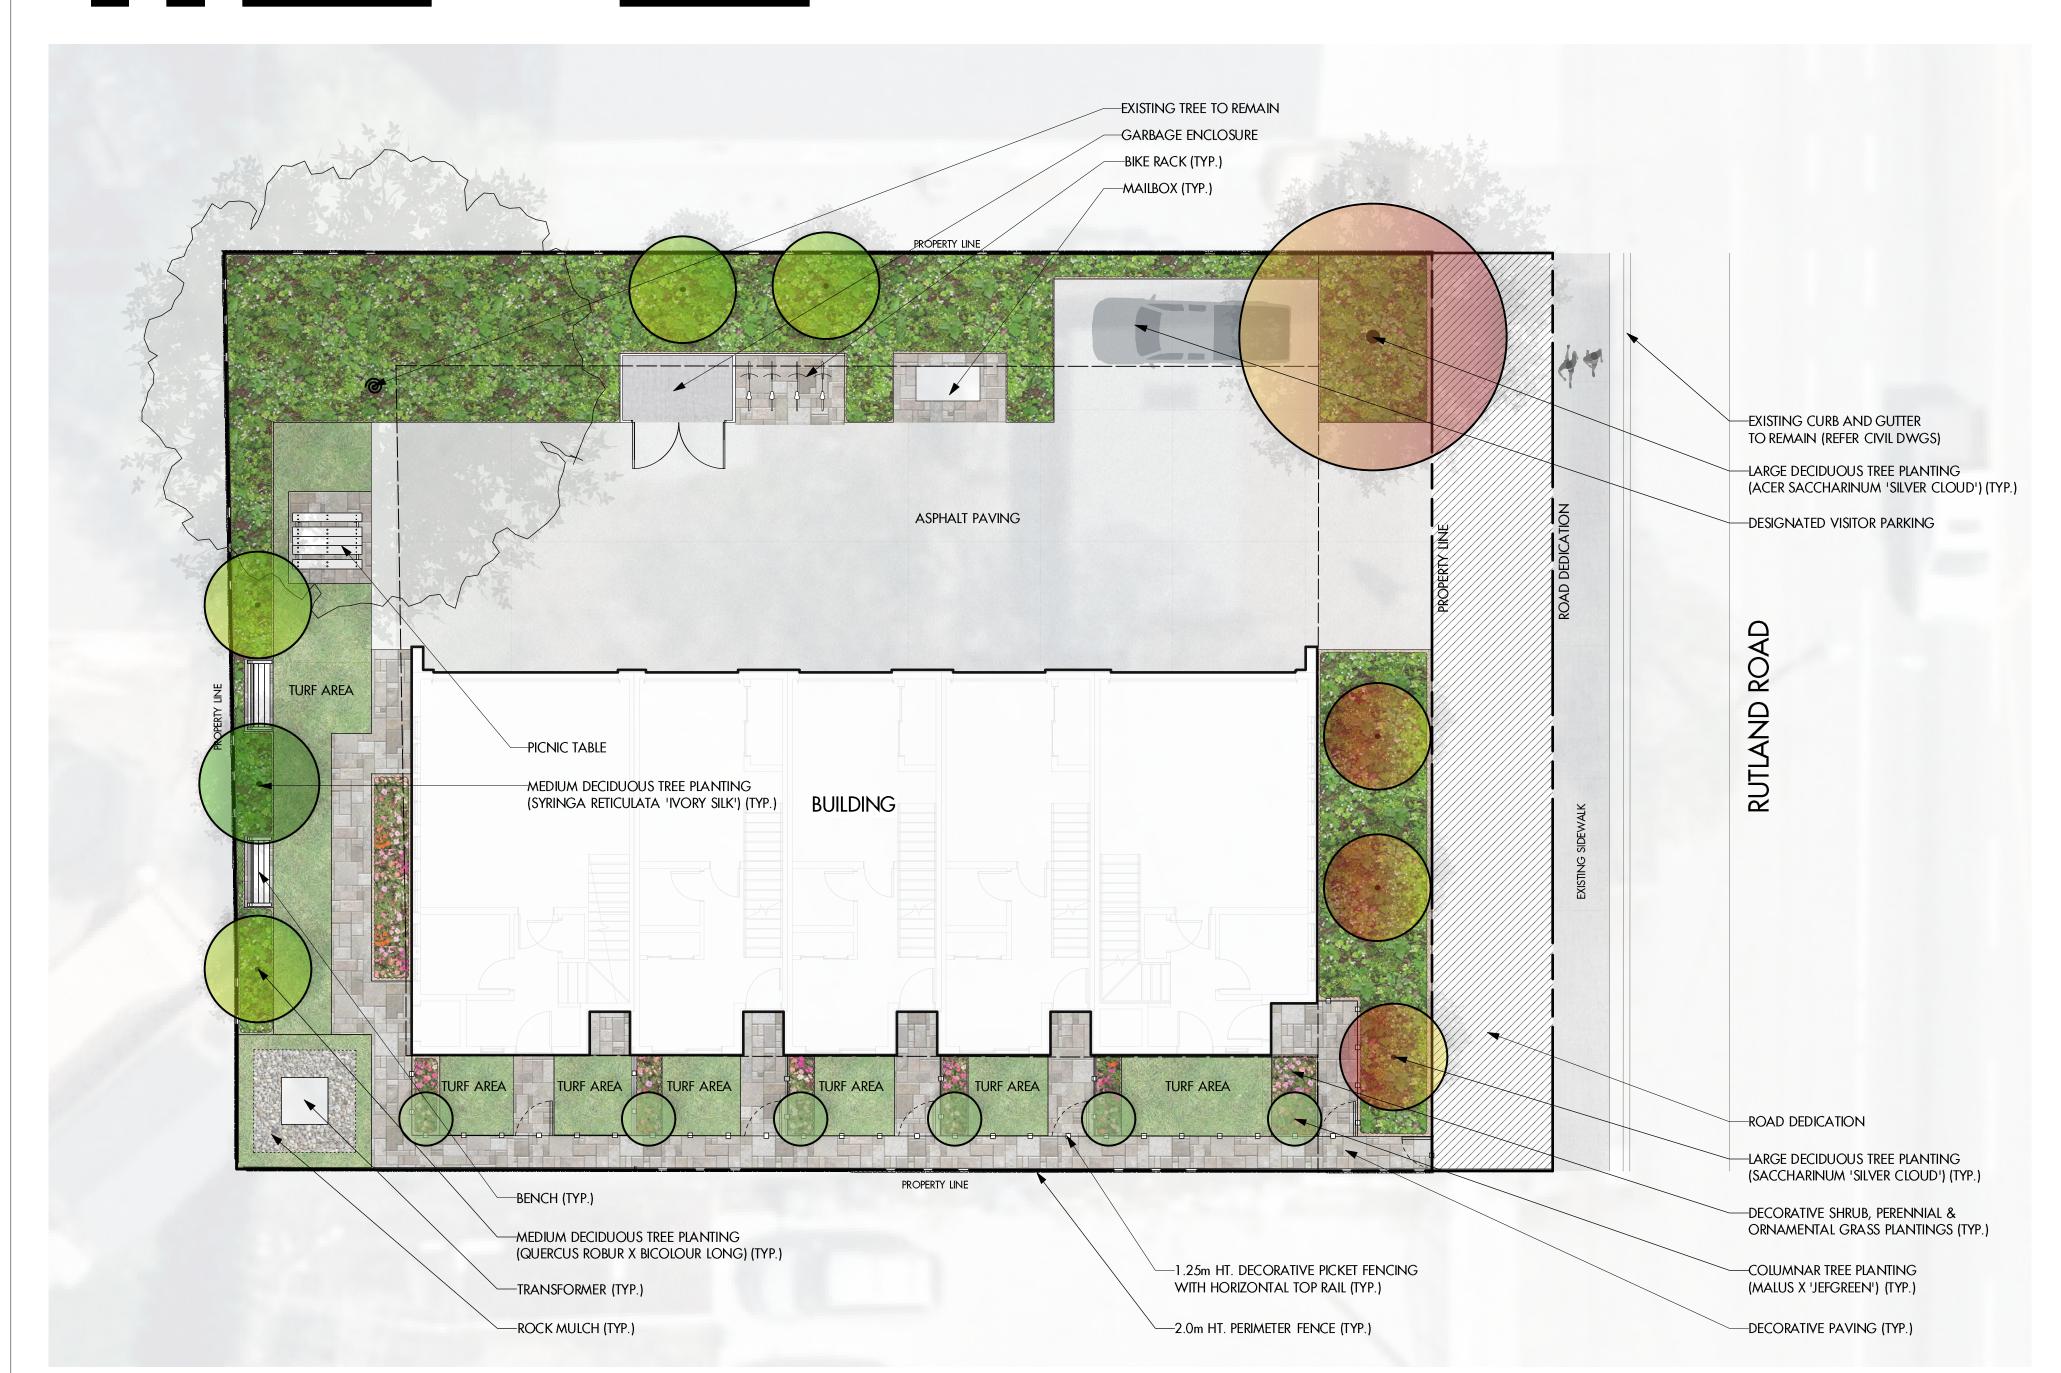

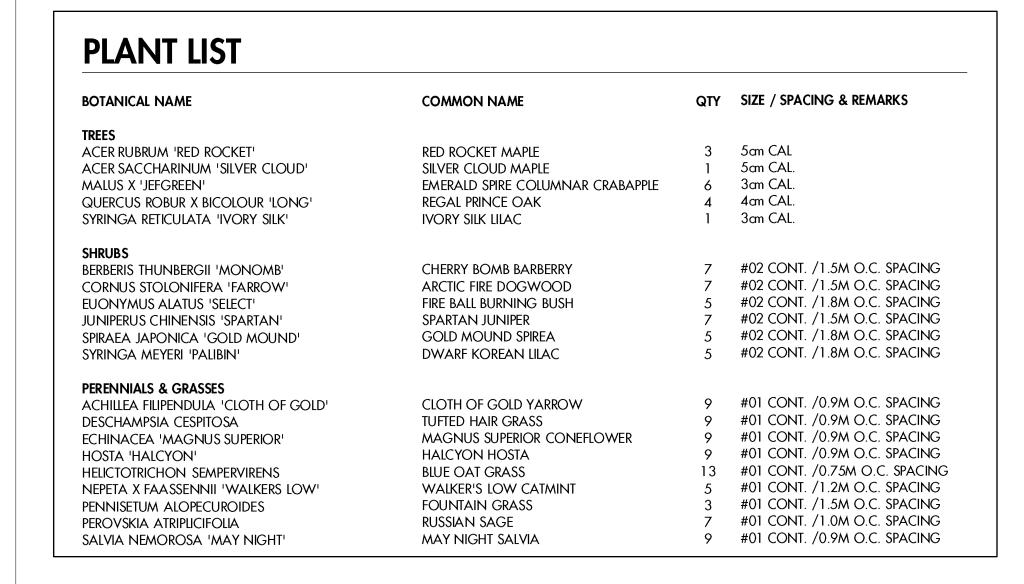

NOTES

1. PLANT MATERIAL AND CONSTRUCTION METHODS SHALL MEET OR EXCEED THE CANADIAN LANDSCAPE STANDARD.

2. ALL SOFT LANDSCAPE AREAS SHALL BE WATERED BY A FULLY AUTOMATIC TIMED UNDERGROUND IRRIGATION SYSTEM.

3. TREE AND SHRUB BEDS TO BE DRESSED IN A MINIMUM 75mm BLACK WOOD

MULCH, AS SHOWN IN PLANS. DO NOT PLACE WEED MAT UNDERNEATH TREE AND SHRUB BEDS.

4. TREE AND SHRUB BEDS TO RECEIVE A MINIMUM 300mm DEPTH TOPSOIL PLACEMENT.

5. TURF AREAS FROM SOD SHALL BE NO. 1 GRADE GROWN FROM CERTIFIED SEED OF IMPROVED CULTIVARS REGISTERED FOR SALE IN B.C. AND SHALL BE TOLERANT OF DROUGHT CONDITIONS. A MINIMUM OF 150mm DEPTH OF GROWING MEDIUM IS REQUIRED BENEATH TURF AREAS. TURF AREAS SHALL MEET EXISTING GRADES AND HARD SURFACES FLUSH.

6. SITE GRADING AND DRAINAGE WILL ENSURE THAT ALL STRUCTURES HAVE POSITIVE DRAINAGE AND THAT NO WATER OR LOOSE IMPEDIMENTS WILL BE DISCHARGED FROM THE LOT ONTO ADJACENT PUBLIC, COMMON, OR PRIVATE PROPERTIES.

7. ALL OFFSITE LANDSCAPE WORKS TO MEET CITY OF KELOWNA BYLAW 7900 STANDARDS.





PROJECT TITLE

920 RUTLAND ROAD

Kelowna, BC

DRAWING TITLE

CONCEPTUAL LANDSCAPE PLAN

		ISSL	jed for / revision	
		1	22.06.27	Review
		2	22.10.28	Review
		3	22.11.04	Review
		4		
		5		

	PROJECT NO	22-0629
	DESIGN BY	GC
	DRAWN BY	PH
	CHECKED BY	FB
	DATE	NOV. 4, 2022
	SCALE	1:100
	PAGE SIZE	24x36"
- 1		

SEAL



drawing number

L 1/2

ISSUED FOR REVIEW ONLY

Copyright Reserved. This drawing is the property of Ecora Engineering & Resource Group Ltd. and shall not be reproduced, resold, or tendered without permission.



Pre-Development Tree Inventory & Assessment

Site Address: 920 Rutland Road, Kelowna BC

Tree List

Trees	Common Name	Scientific Name	DBH	Comments
1	Black Locust	Robina pseudo acacia	18.15cm	Location: Front yard outside fence beside the sidewalk. Heavy crown reduction pruning in past. Located beneath primary Hydro lines.
2	Black Locust	Robina pseudo acacia	23.56cm	Location: Front of house inside fence. Heavy crown reduction in past. Located under primary Hydro lines.
3	Siberian Elm	Ulmus pumila	75.15cm	Location: Back right corner of the property. Invasive species, large dead limbs in upper canopy.
4	Black Locust	Robina pseudo acacia	32.48cm	Location: Left side backyard just inside fence line. Understory tree with heavy lean growing out from under tree #5
5	Black Locust	Robina pseudo acacia	100.95cm	Location: Left side of house at back of driveway. Past crown reduction pruning for Hydro line clearance.
6	Siberian Elm/Black Locust	Ulmus pumila/Robina pseudo acacia	under 2.5cm	Multiple small volunteer sucker growth throughout property.

